

KEY PLAN SCALE:NTS

THE OWNER AND OPERATOR SHALL PROVIDE A COPY OF THE ANNUAL INSPECTION AND SERVICE RECORDS FOR THE OGS UNIT AND STORAGE CHAMBERS TO THE TOWN OF COBOURG DIRECTOR OF PUBLIC

MUNICIPAL ADDRESS & LEGAL DESCRIPTION 428 & 432 KING STREET EAST, TOWN OF COBOURG
PART OF LOT 12, CONCESSIONA,
GEOGRAPHIC TOWNSHIP OF
HAMILTON, TOWN OF COBOURG,

ELEVATION ELEVATIONS ARE GEODETIC AND REFERRED TO THE CANADIAN GEODETIC VERTICAL DATA DATUM (CGVD28) BY DIRECT MEASUREMENT TO A REAL TIME NETWORK.

COUNTY OF NORTHUMBERLAND

VICE PRESIDENT, OPERATIONS 10 Wanless Avenue, Suite 201, Toronto, ON M4N1V6T. 416.481.2222 × 253 | F. 647.789.5189 E. agold@plazacorp.com

APPLICANT n Architecture Inc 9120 LESLIE STREET. SUITE-208, RICHMOND HILL, ONTARIO L4B 3J9 T: 416.303.4821 E: Info@narchitecture.com

www.narchitecture.com

PHASE-2 PHASE-1

STORMWATER MANAGEMENT TO BE DESIGNED IN

Parks, Forestry and Recreation

February 2016 Detail TP-1

DUTY DUTY IN CONFORMANCE WITH OPSS

50 50 150 | 150

300 450

PHASE 2 DEVELOPMENT AND STM SEWER TO

BE CONNECTED TO PROPOSED STM PLUG.

LEGEND

— — — MINIMUM SET BACK PROPOSED CONCRETE CURB 1M D/C PROPOSED DEPRESSED CONCRETE CURB _____ EXISTING STORM MANHOLE

PROPERTY LINE

PROPOSED STORM MANHOLE EX. CB EXISTING CATCH BASIN □ СВ PROPOSED CATCH BASIN PROPOSED CATCH BASIN MANHOLE (()) EX MH1A EXISTING SANITARY MANHOLE PROPOSED SANITARY MANHOLE EXISTING WATER VALVE PROPOSED WATER VALVE

FIRE HYDRANT UTILITY POLE BARRIER FREE PARKING

OVER HEAD DOOR LANDSCAPED AREA DEPRESSED CURB FINISHED FLOOR ELEVATION

MAIN ENTRANCE

PAINTED LINE RETAINING WALL

EXISTING ELEVATION 174.00 100 YR. STORM HWL AREA

OVERLAND FLOW ROUTE

HEAVY DUTY ASPHALT

CONCRETE

GENERAL NOTES
READ THIS DRAWING IN CONJUNCTION WITH ARCHITECTURAL, MECHANICAL AND LANDSCAPING PLANS. 1. ALL WORK SHALL BE CARRIED OUT IN COMPLIANCE WITH THE APPLICABLE HEALTH AND SAFETY ACT AND REGULATIONS FOR CONSTRUCTION PROJECTS. 2.ALL INSTALLATION WORK, MATERIALS AND CONSTRUCTION METHODS TO CONFORM WITH THE LATEST STANDARDS, SPECIFICATIONS, POLICIES, REGULATIONS, GUIDELINES AND LAWS FOR THE TOWN OF COBOURG, THE ONTARIO BUILDING CODE (OBC), MINISTRY OF THE ENVIRONMENT (MOE), ONTARIO PROVINCIAL STANDARD DRAWING AND SPECIFICATIONS (OPSD AND OPSS), THE ENVIRONMENTAL PROTECTION ACT AND THE WATER RESOURCES ACT, LUSI 2020 WATERMAIN & APPURTENANCE POLICY, THE MINISTRY OF TRANSPORTATION STANDARDS WILL APPLY WHERE REQUIRED.

- 3. ALL MATERIAL USED FOR SITE SERVICING TO BE COMPLIED WITH OBC SECTION a) SANITARY AND STORM WATER PIPES HAS TO BE HDPE 3408 SDR 17, AND WATER PIPES HAS TO BE CAN/CSA-B137-9 COMPLIENT (OBC 7.2.5.13)
- b) PVC WATER PIPE, FITTINGS AND SOLVENT CEMENT SHALL BE CERTIFIED TO CAN/CSA-B137.3, "RIGID POLYVINYLCHLORIDE (PVC) PIPE AND FITTINGS FOR PRESSURE APPLICATIONS" OR CAN/CSA-B137.2, "POLYVINYLCHLORIDE (PVC) INJECTION-MOULDED GASKETED FITTINGS FOR PRESSURE APPLICATIONS", AND HAVE MINIMUM PRESSURE RATING OF 1 100 KPA.
- c) COPPER PIPE SHALL CONFORM TO ASTM B42, "SEAMLESS COPPER PIPE,

OF PRIVATE FIRE SERVICE MAINS AND THEIR APPURTENANCES".

- d) CONCRETE PIPE SHALL CONFORM TO CAN/CSA-A257 SERIES, "STANDARDS e) FIRE SERVICE MAINS AND WATER SERVICE PIPE COMBINED WITH FIRE
- f) MAINTENANCES HOLES AND CATCHBASINS CAST IRON COVERS & LIDS SHALL CONFORM TO CAN/CSA-B170.1

SERVICE MAINS SHALL BE IN CONFORMANCE WITH NFPA 24, "INSTALLATION

4.THE INFORMATION SHOWN FOR EXISTING UTILITIES WAS COMPILED FROM LOCATES INFORMATION AND RECORD DRAWINGS FROM THE TOWN. THE INFORMATION IS SHOWN FOR GENERAL INFORMATION ONLY AND THE ACCURACY OR COMPLETENESS OF THE PROVIDED INFORMATION HAS NOT BEEN CONFIRMED. THE CONTRACTOR IS RESPONSIBLE FOR LOCATING AND PROTECTING ALL UTILITIES DURING CONSTRUCTION. ALL EXISTING UTILITIES MUST BE LOCATED AND VERIFIED BY THE CONTRACTOR PRIOR TO COMMENCEMENT OF WORK. ANY VARIANCE IS TO BE IMMEDIATELY REPORTED TO THE ENGINEER. LOST TIME DUE TO FAILURE OF THE CONTRACTOR TO CONFIRM UTILITY LOCATIONS AND NOTIFY THE ENGINEER OF POSSIBLE CONFLICTS PRIOR TO CONSTRUCTION WILL BE AT THE CONTRACTOR'S POSSIBLE CONFLICTS PRIOR TO CONSTRUCTION WILL BE AT THE CONTRACTOR'S

5.PLAN SHOULD BE READ IN CONJUNCTION WITH ALL OTHER CONSULTANTS' PLANS. ANY DISCREPANCIES SHALL BE CLARIFIED PRIOR TO CONSTRUCTION. INFORMATION RELATED TO DIMENSIONS FOR PRIVATE ROADS, PARKING, CURBING, BUILDING LOCATION AND SETBACKS SHALL BE TAKEN FROM THE SITE PLAN PREPARED BY 6.ALL DIMENSIONS AND ELEVATIONS TO BE VERIFIED PRIOR TO CONSTRUCTION AND ANY DISCREPANCIES FOUND PRIOR TO OR DURING CONSTRUCTION SHALL BE CLARIFIED WITH THE ENGINEER.


ALL WORK IN THE MUNICIPAL RIGHT OF WAY AND EASEMENTS IS TO BE INSPECTE 'THE TOWN PRIOR TO BACKFILLING. ALL WORK RELATING TO WATERMAINS AN SEWERS TO BE INSPECTED BY THE TOWN AS PER THE SITE PLAN AGREEMENT. 8.ALL DISTURBED GRASSED AREAS TO BE RESTORED WITH MINIMUM 200MM TOPSOIL AND NO. 1 NURSERY SOD.


9.THE CONTRACTOR AGREES NOT TO MAKE A MATERIAL CHANGE OR CAUSE A MATERIAL CHANGE TO BE MADE TO A PLAN, SPECIFICATION, DOCUMENT OR OTHER INFORMATION, ON THE BASIS OF WHICH THIS DRAWING WAS APPROVED BY THE CITY, WITHOUT NOTIFYING, FILING DETAILS WITH AND OBTAINING WRITTEN AUTHORIZATION OF THE TOWN AND PROJECT ENGINEER. 10. ALL WORK INSIDE THE PROPERTY LINE OF THE SITE IS TO BE INSPECTED BY NARCHITECTURE INC. PRIOR TO BACKFILLING, ALL WORK RELATING TO WATERMAINS AND SEWERS TO BE INSPECTED BY NARCHITECTURE AS PER APPROVED PLANS BY THE TOWN.

n Architecture Inc

PRINCIPAL: NITIN MALHOTRA, ARCHITECT 9120 Leslie Street, Suite-208 Richmond Hill, Ontario. L4B 3J9 T: 4 1 6 . 3 0 3 . 4 8 2 1 E: info@narchitecture.com www.narchitecture.com



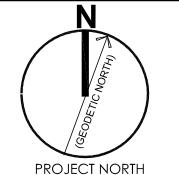

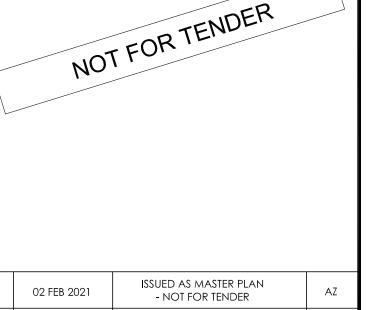

LUSI NOTE ADDED

and issued for spa III

OMMENTS ON 3RD PRE-SUBMISSION

ADDRESSED AND ISSUED FOR SPA III

COMMENTS ON 2ND SUBMISSION ADDRESSED AND ISSUED FOR SPA III

COMMENTS ON 1ST SUBMISSION

ADDRESSED AND ISSUED FOR SPA II

COMMENTS ON REVIEW 10 MAR 2020 ADDRESSED AND ISSUED FOR SPAIL ISSUED FOR REVIEW 12 FEB 2020 Date This drawing is copyright property of 'n Architecture Inc'. Not to be reproduced. Contractor must verify all job dimensions, drawings, details and specifications and report

any discrepancies to the architect before

proceeding with work.

17 DEC 2020


30 OCT 2020

COMMERCIAL **DEVELOPMENT** 428 AND 432 KING STREET EAST, COBOURG, ON

DRAWING TITLE:

SITE GRADING PLAN


DRAWN BY: AZ	DATE: OCT 21 2019
CHECKED BY: AZ	SCALE: 1:250
PROJECT NO.:	DRAWING NO.:

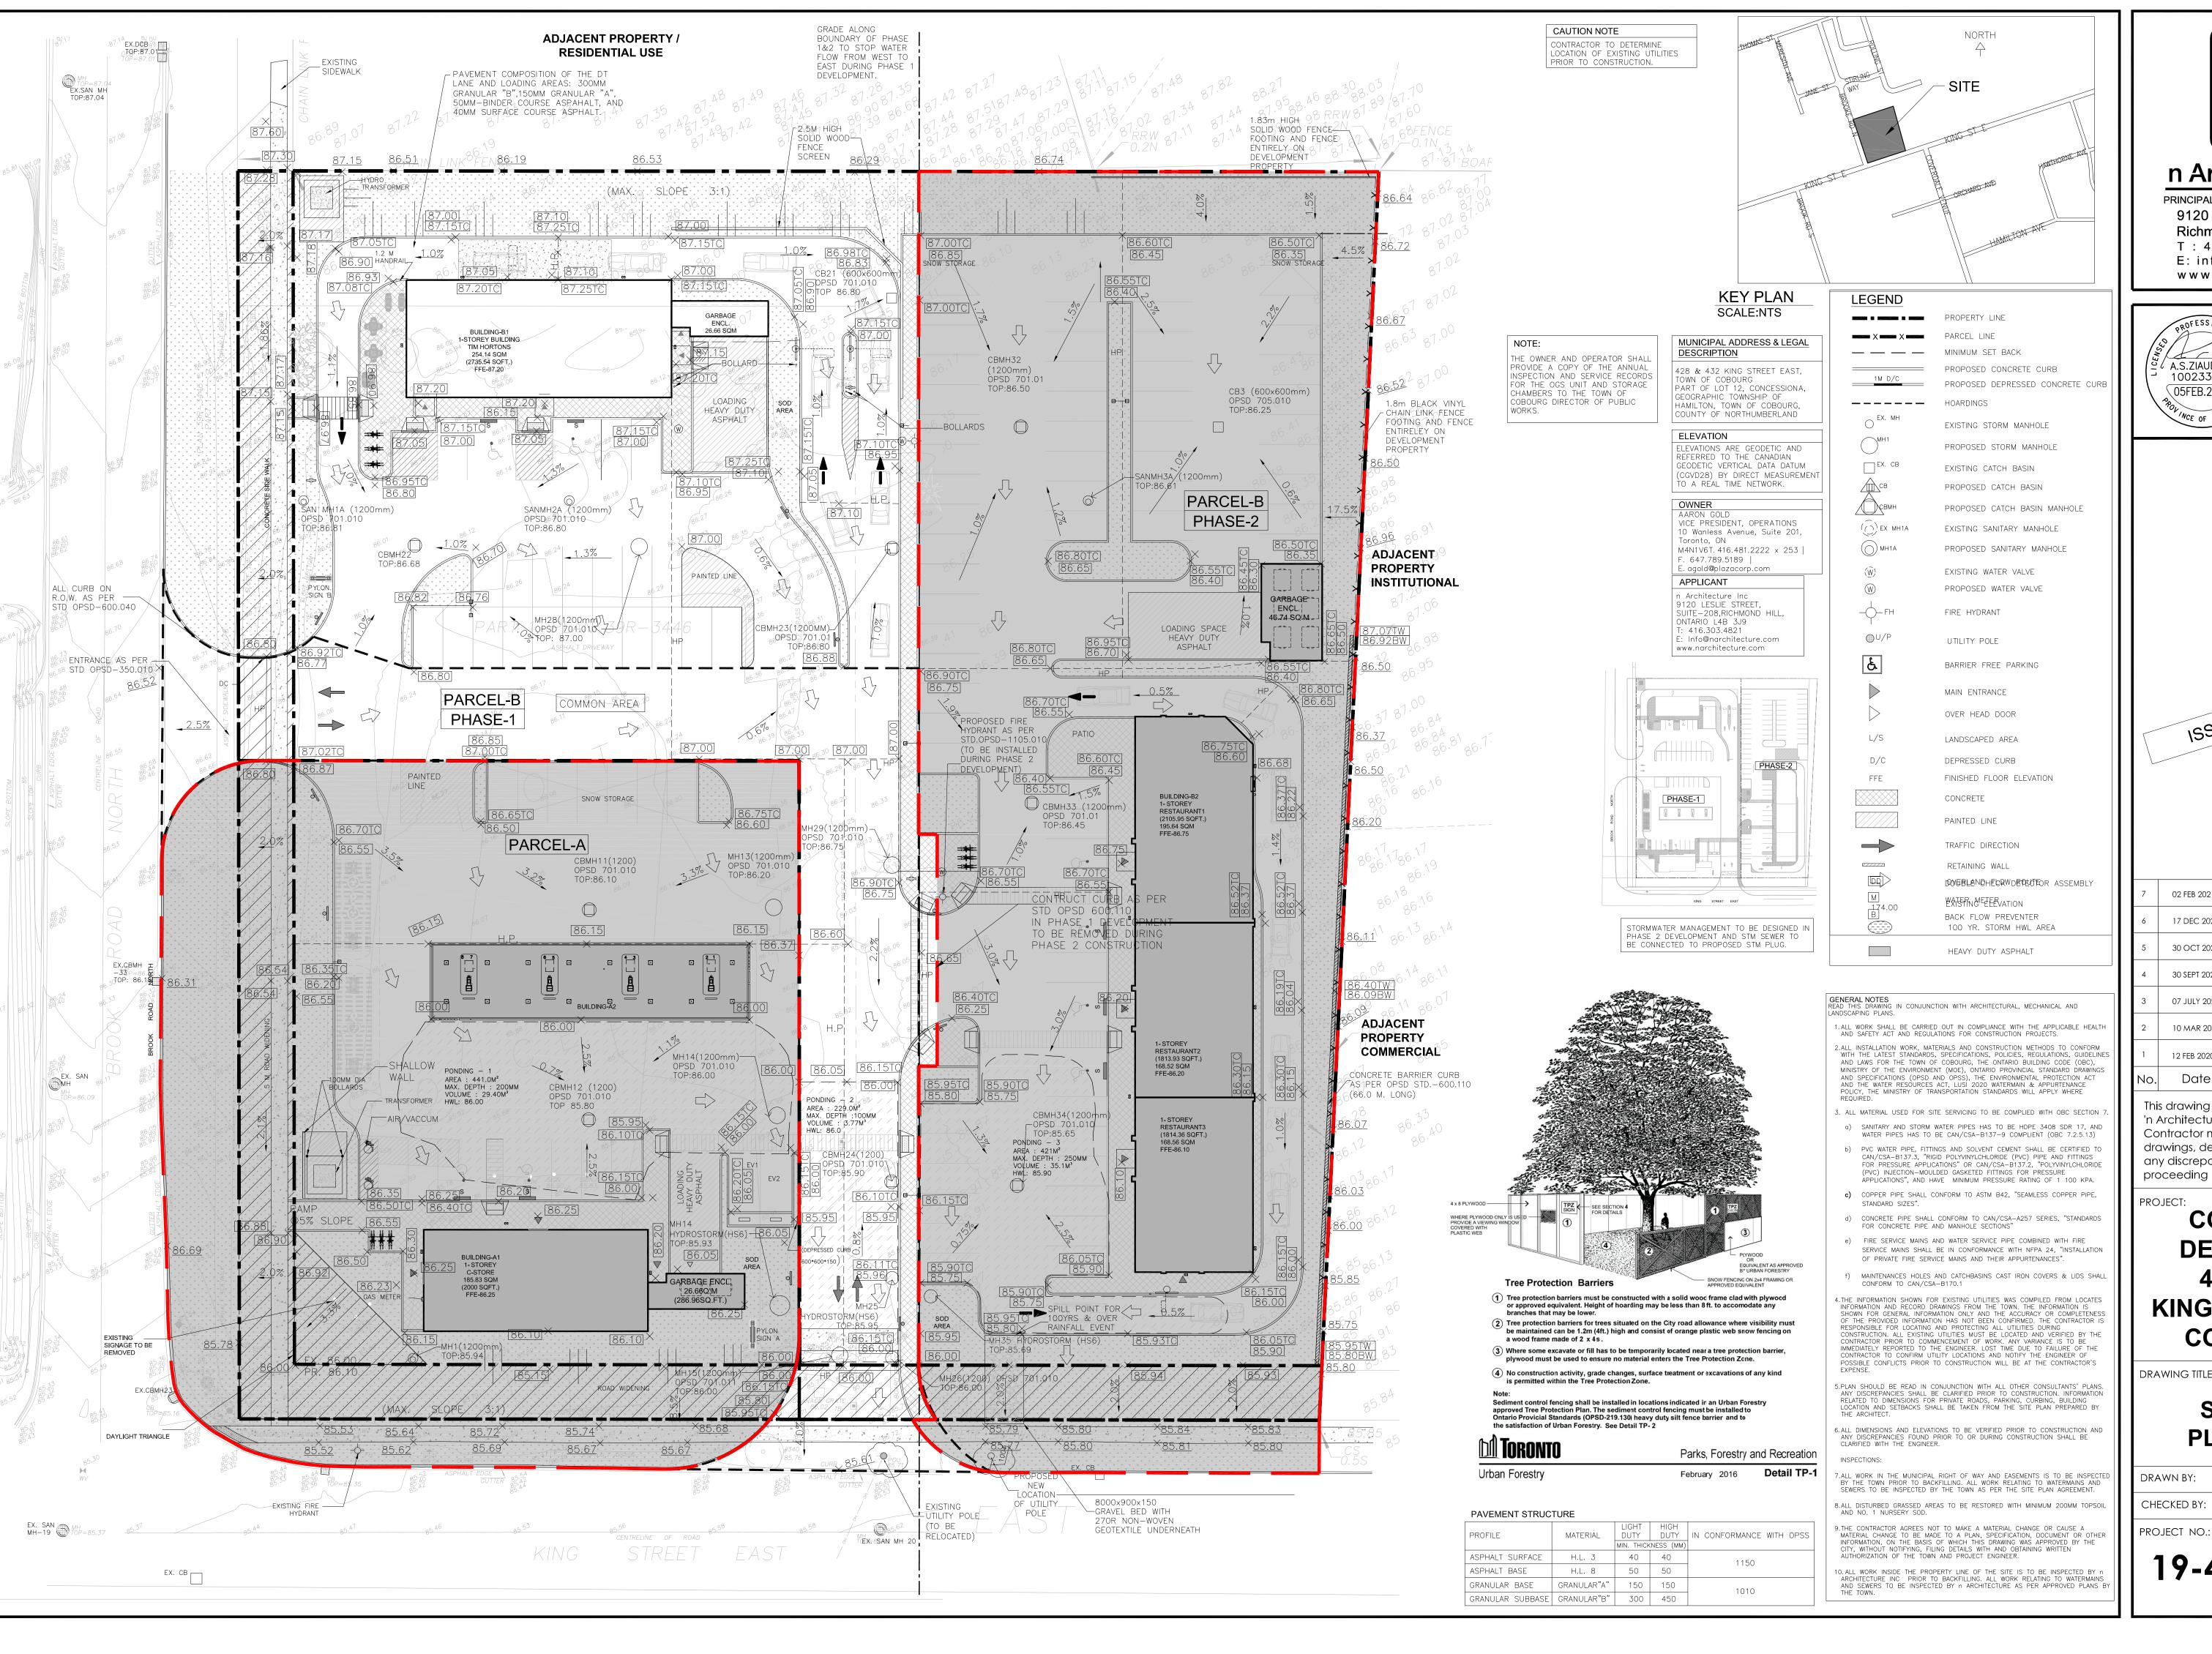


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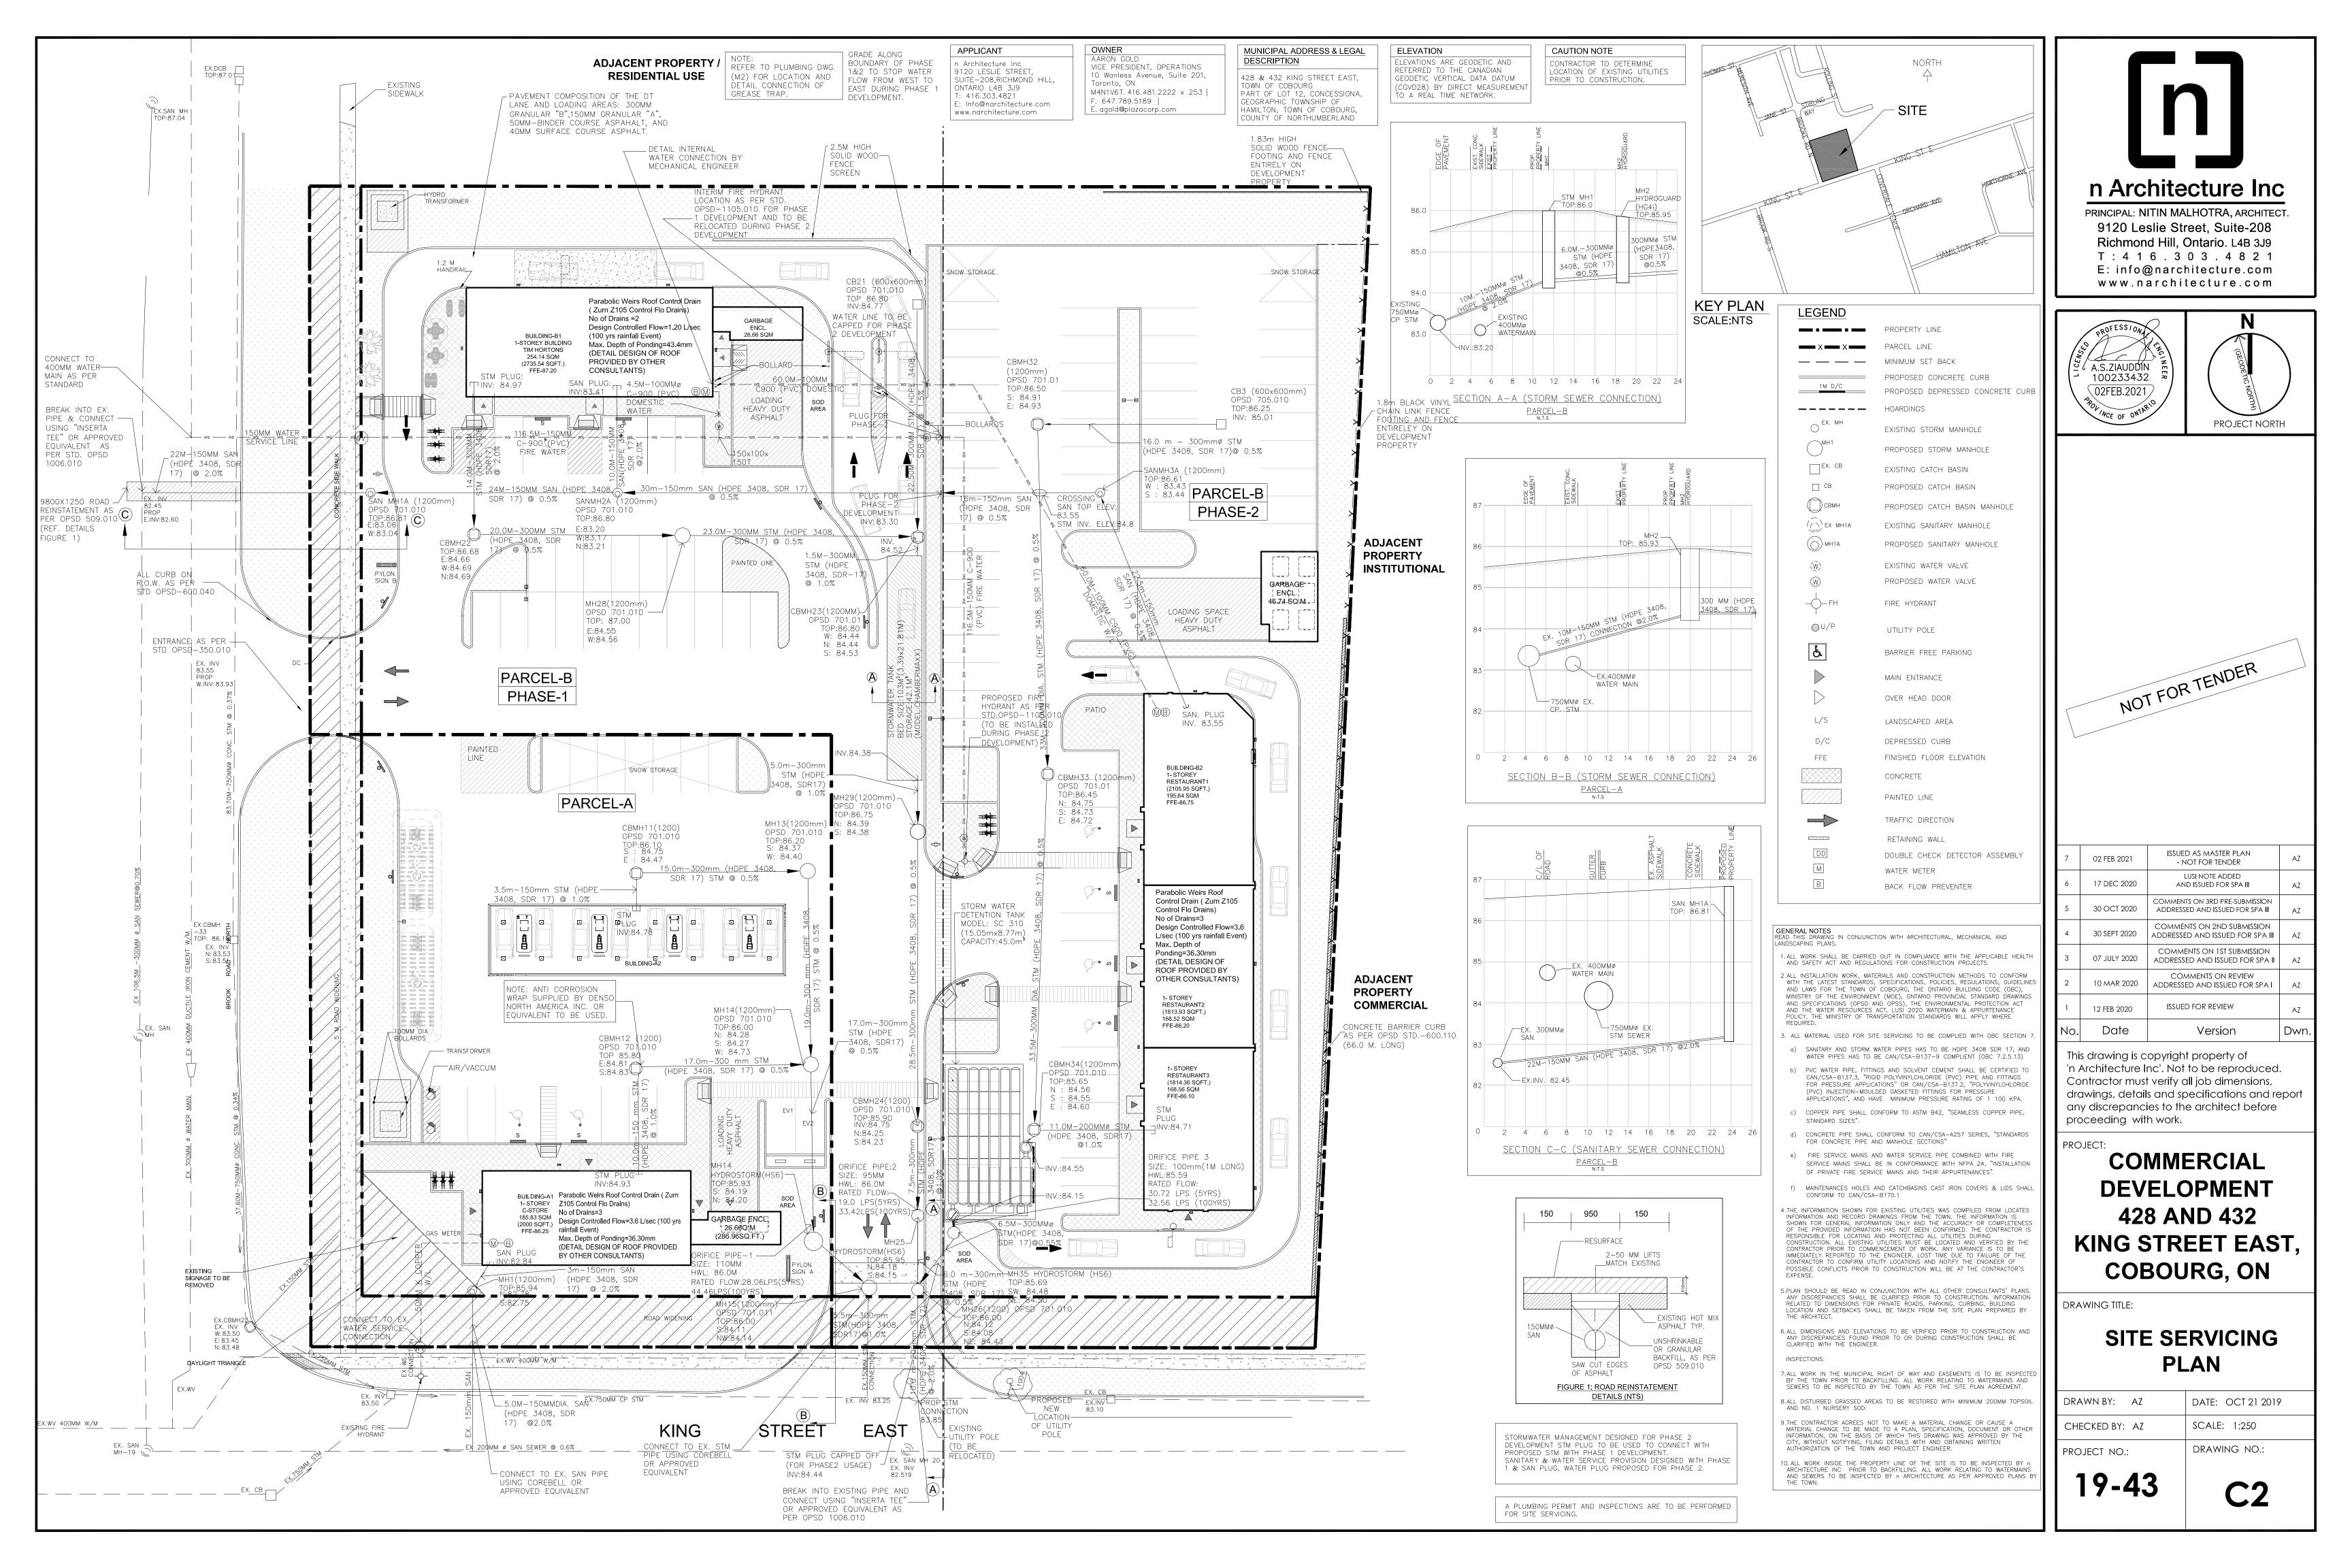
COMMERCIAL **DEVELOPMENT** 428 AND 432 KING STREET EAST, COBOURG, ON


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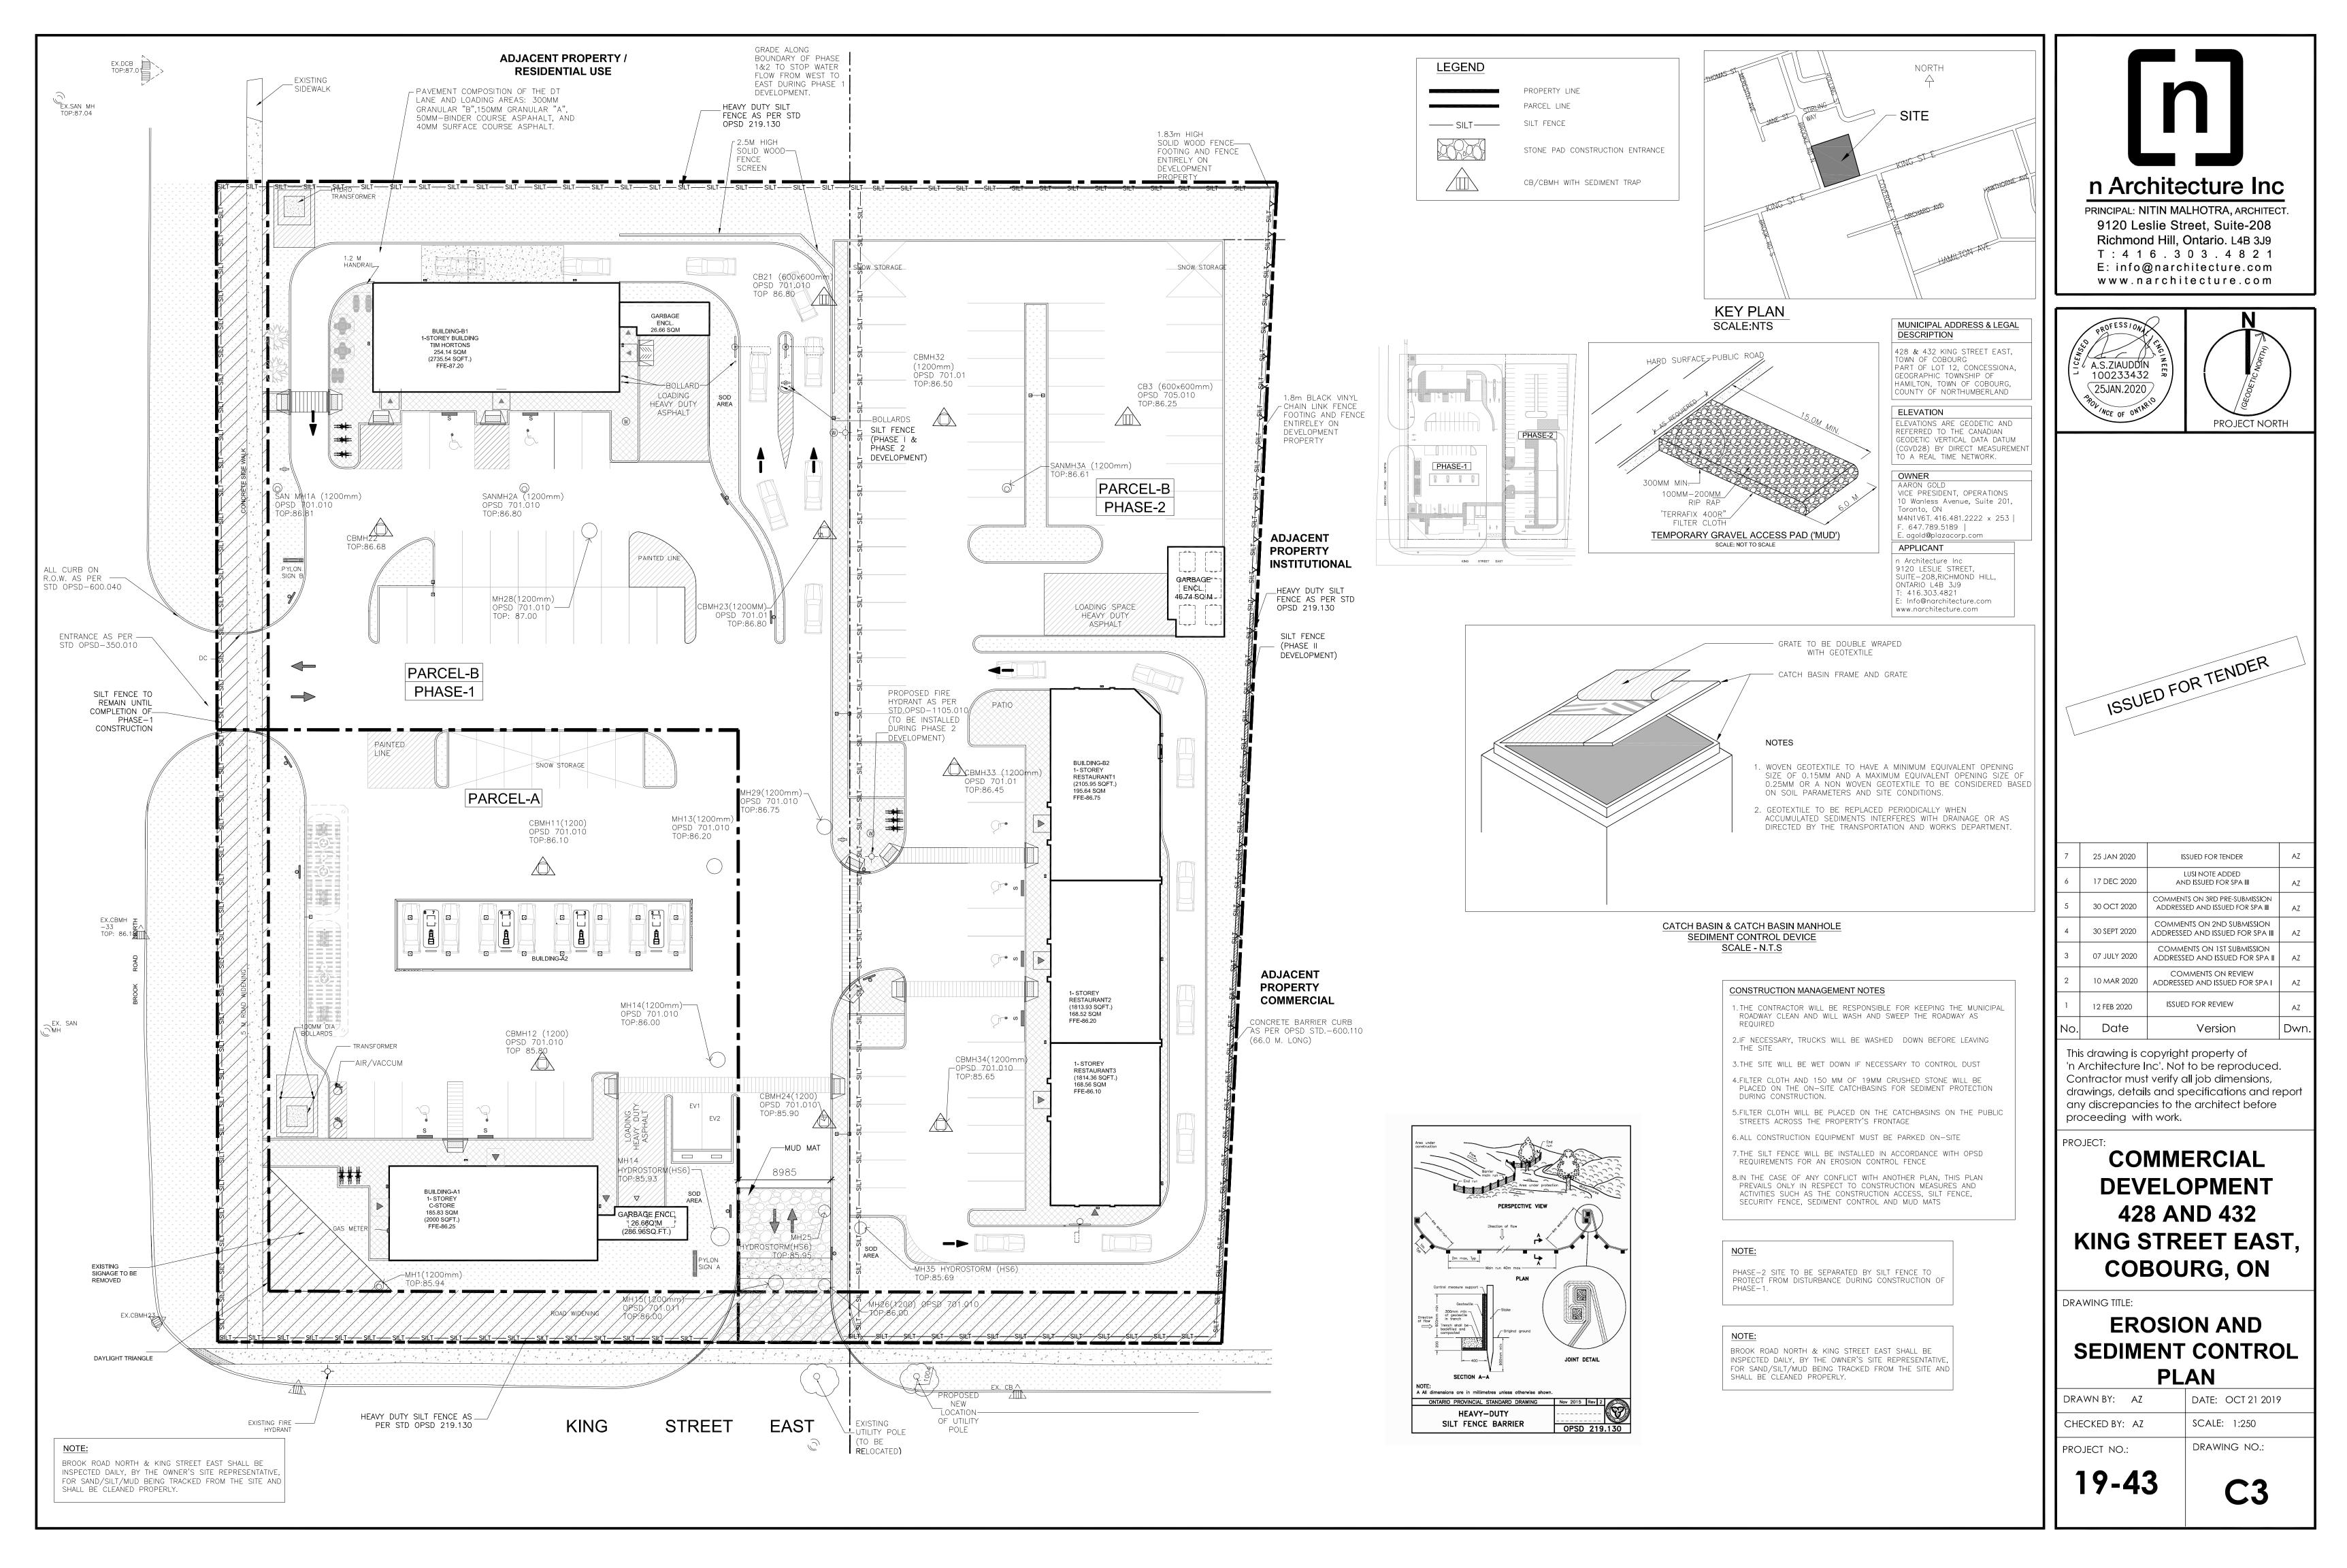
SITE GRADING PLAN (PHASE 1)


	DRAWN BY: AZ	DATE: OCT 21 2019
	CHECKED BY: AZ	SCALE: 1:250
	PROJECT NO.:	DRAWING NO.:

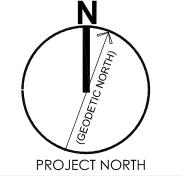
C1-P1

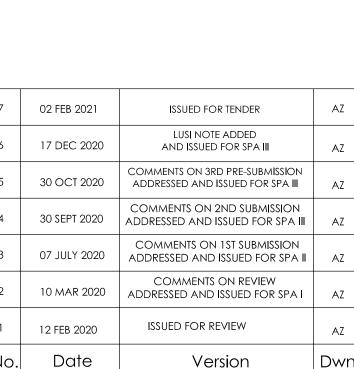



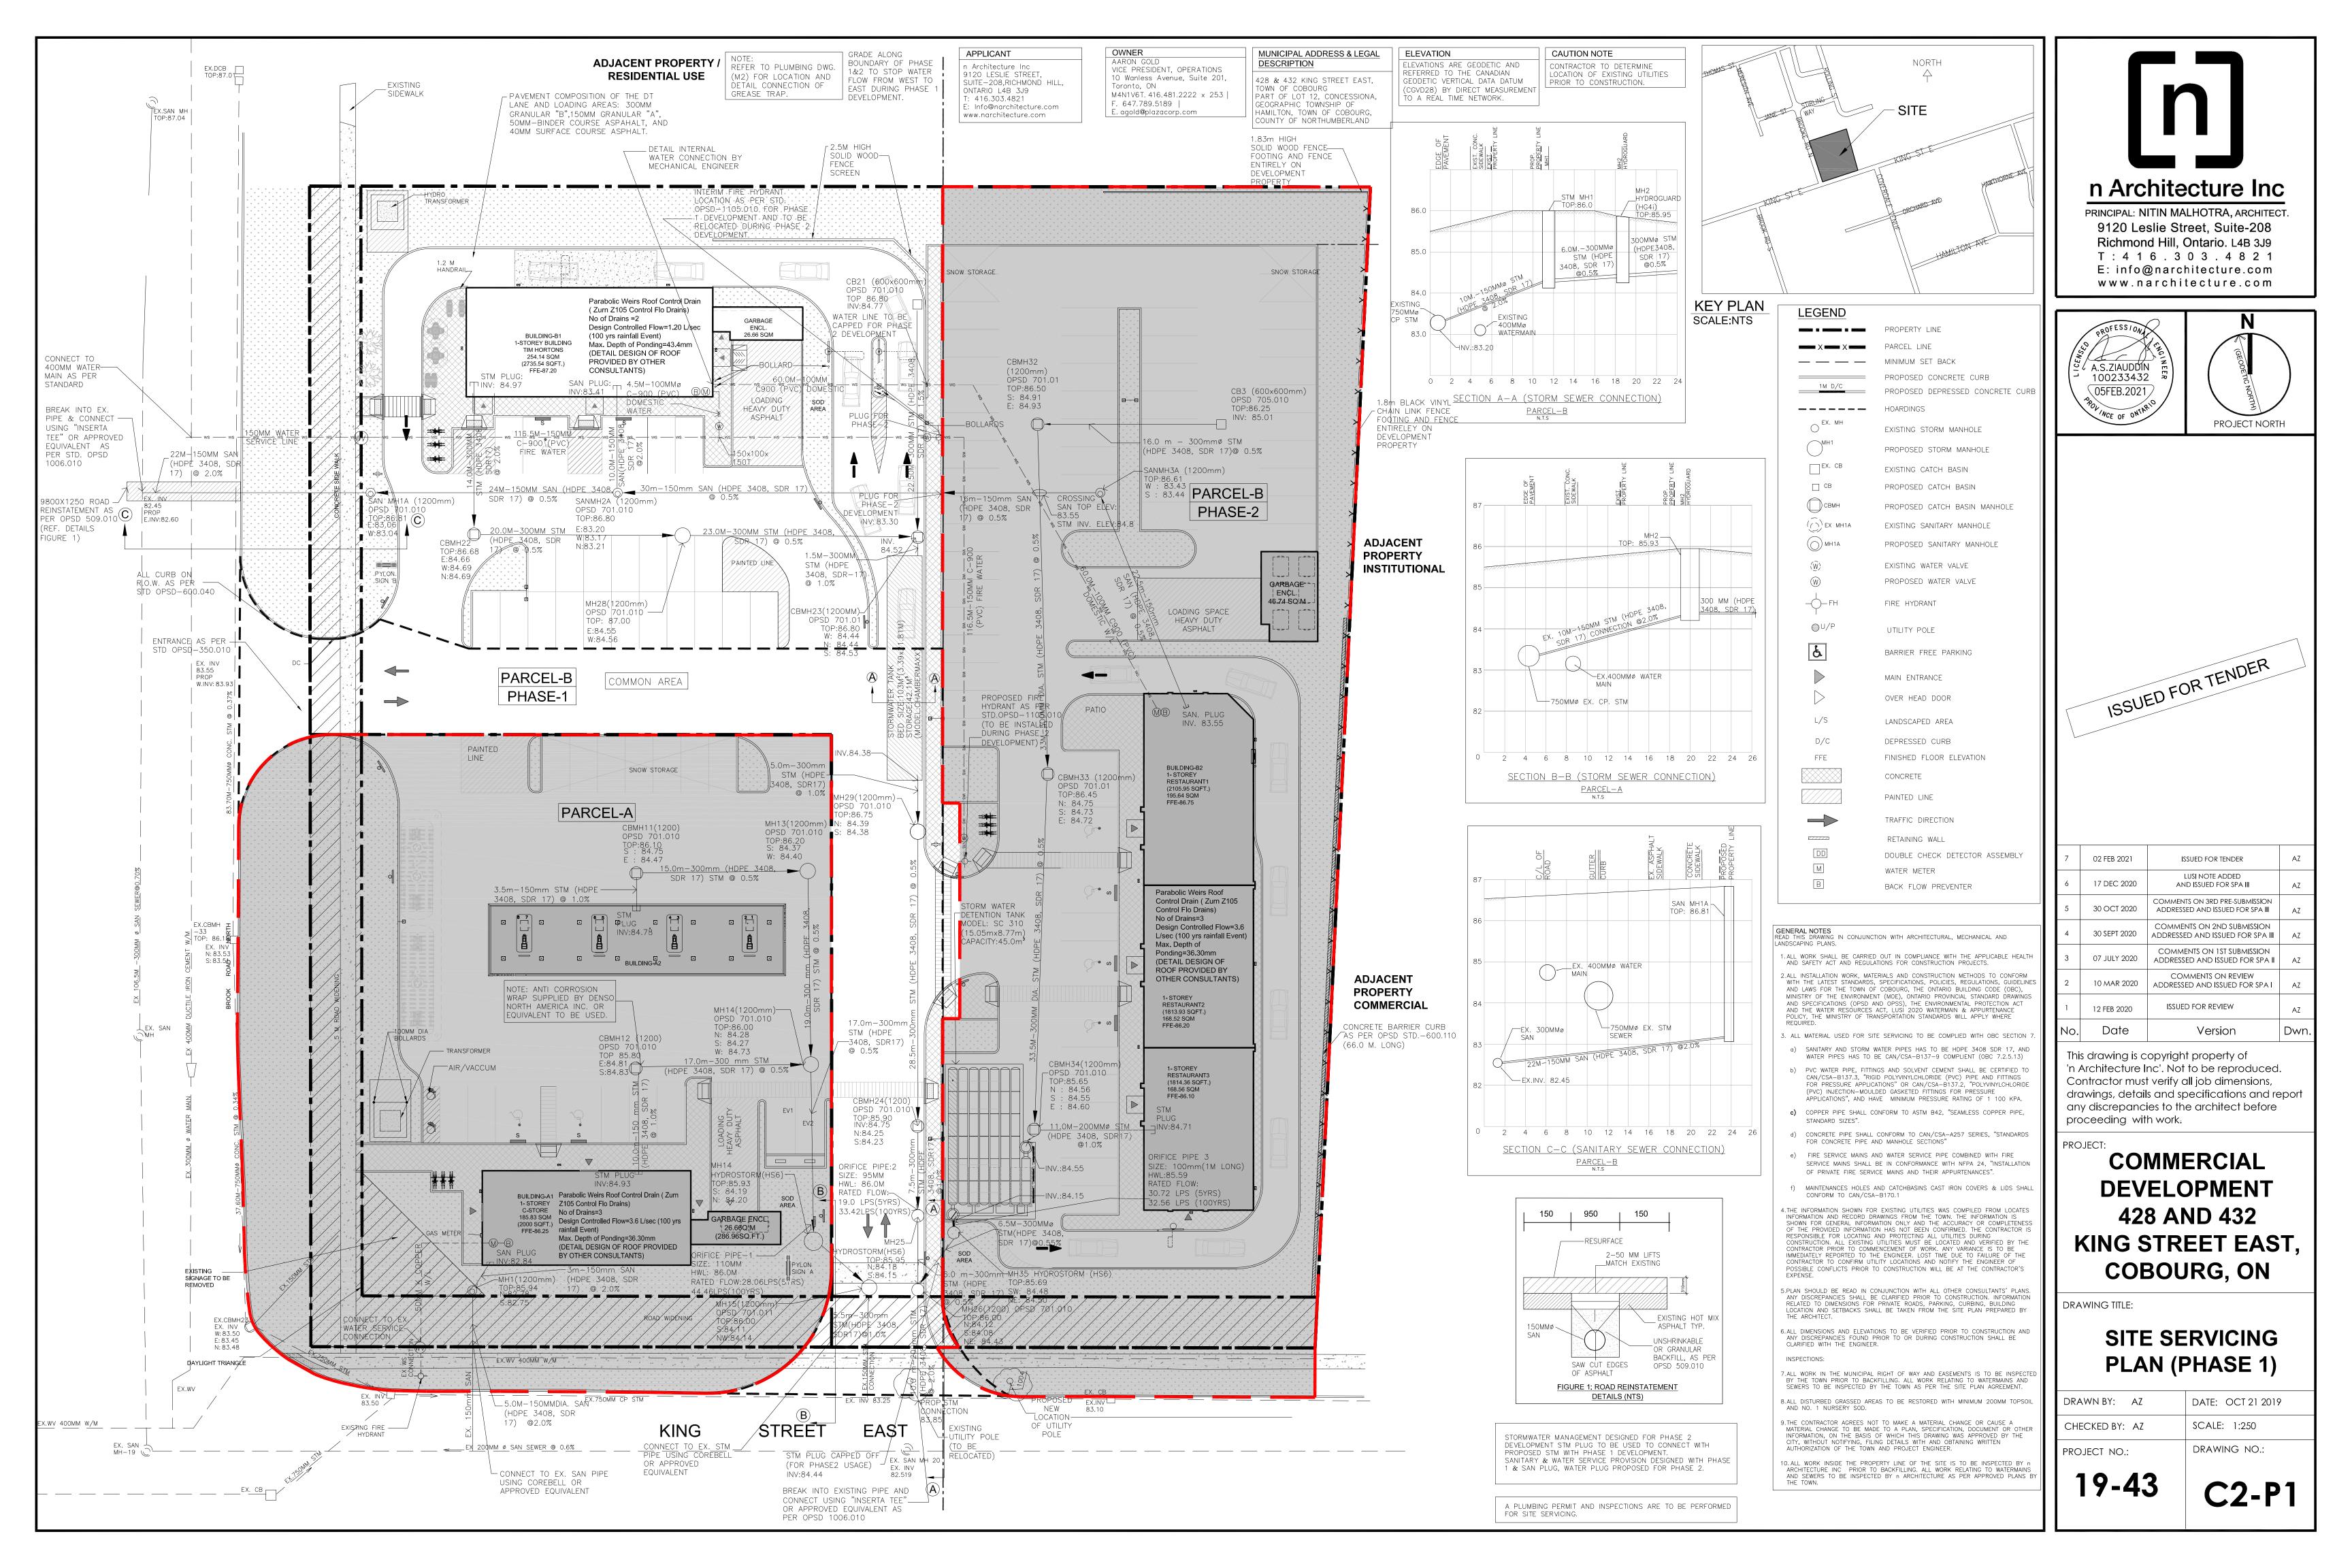

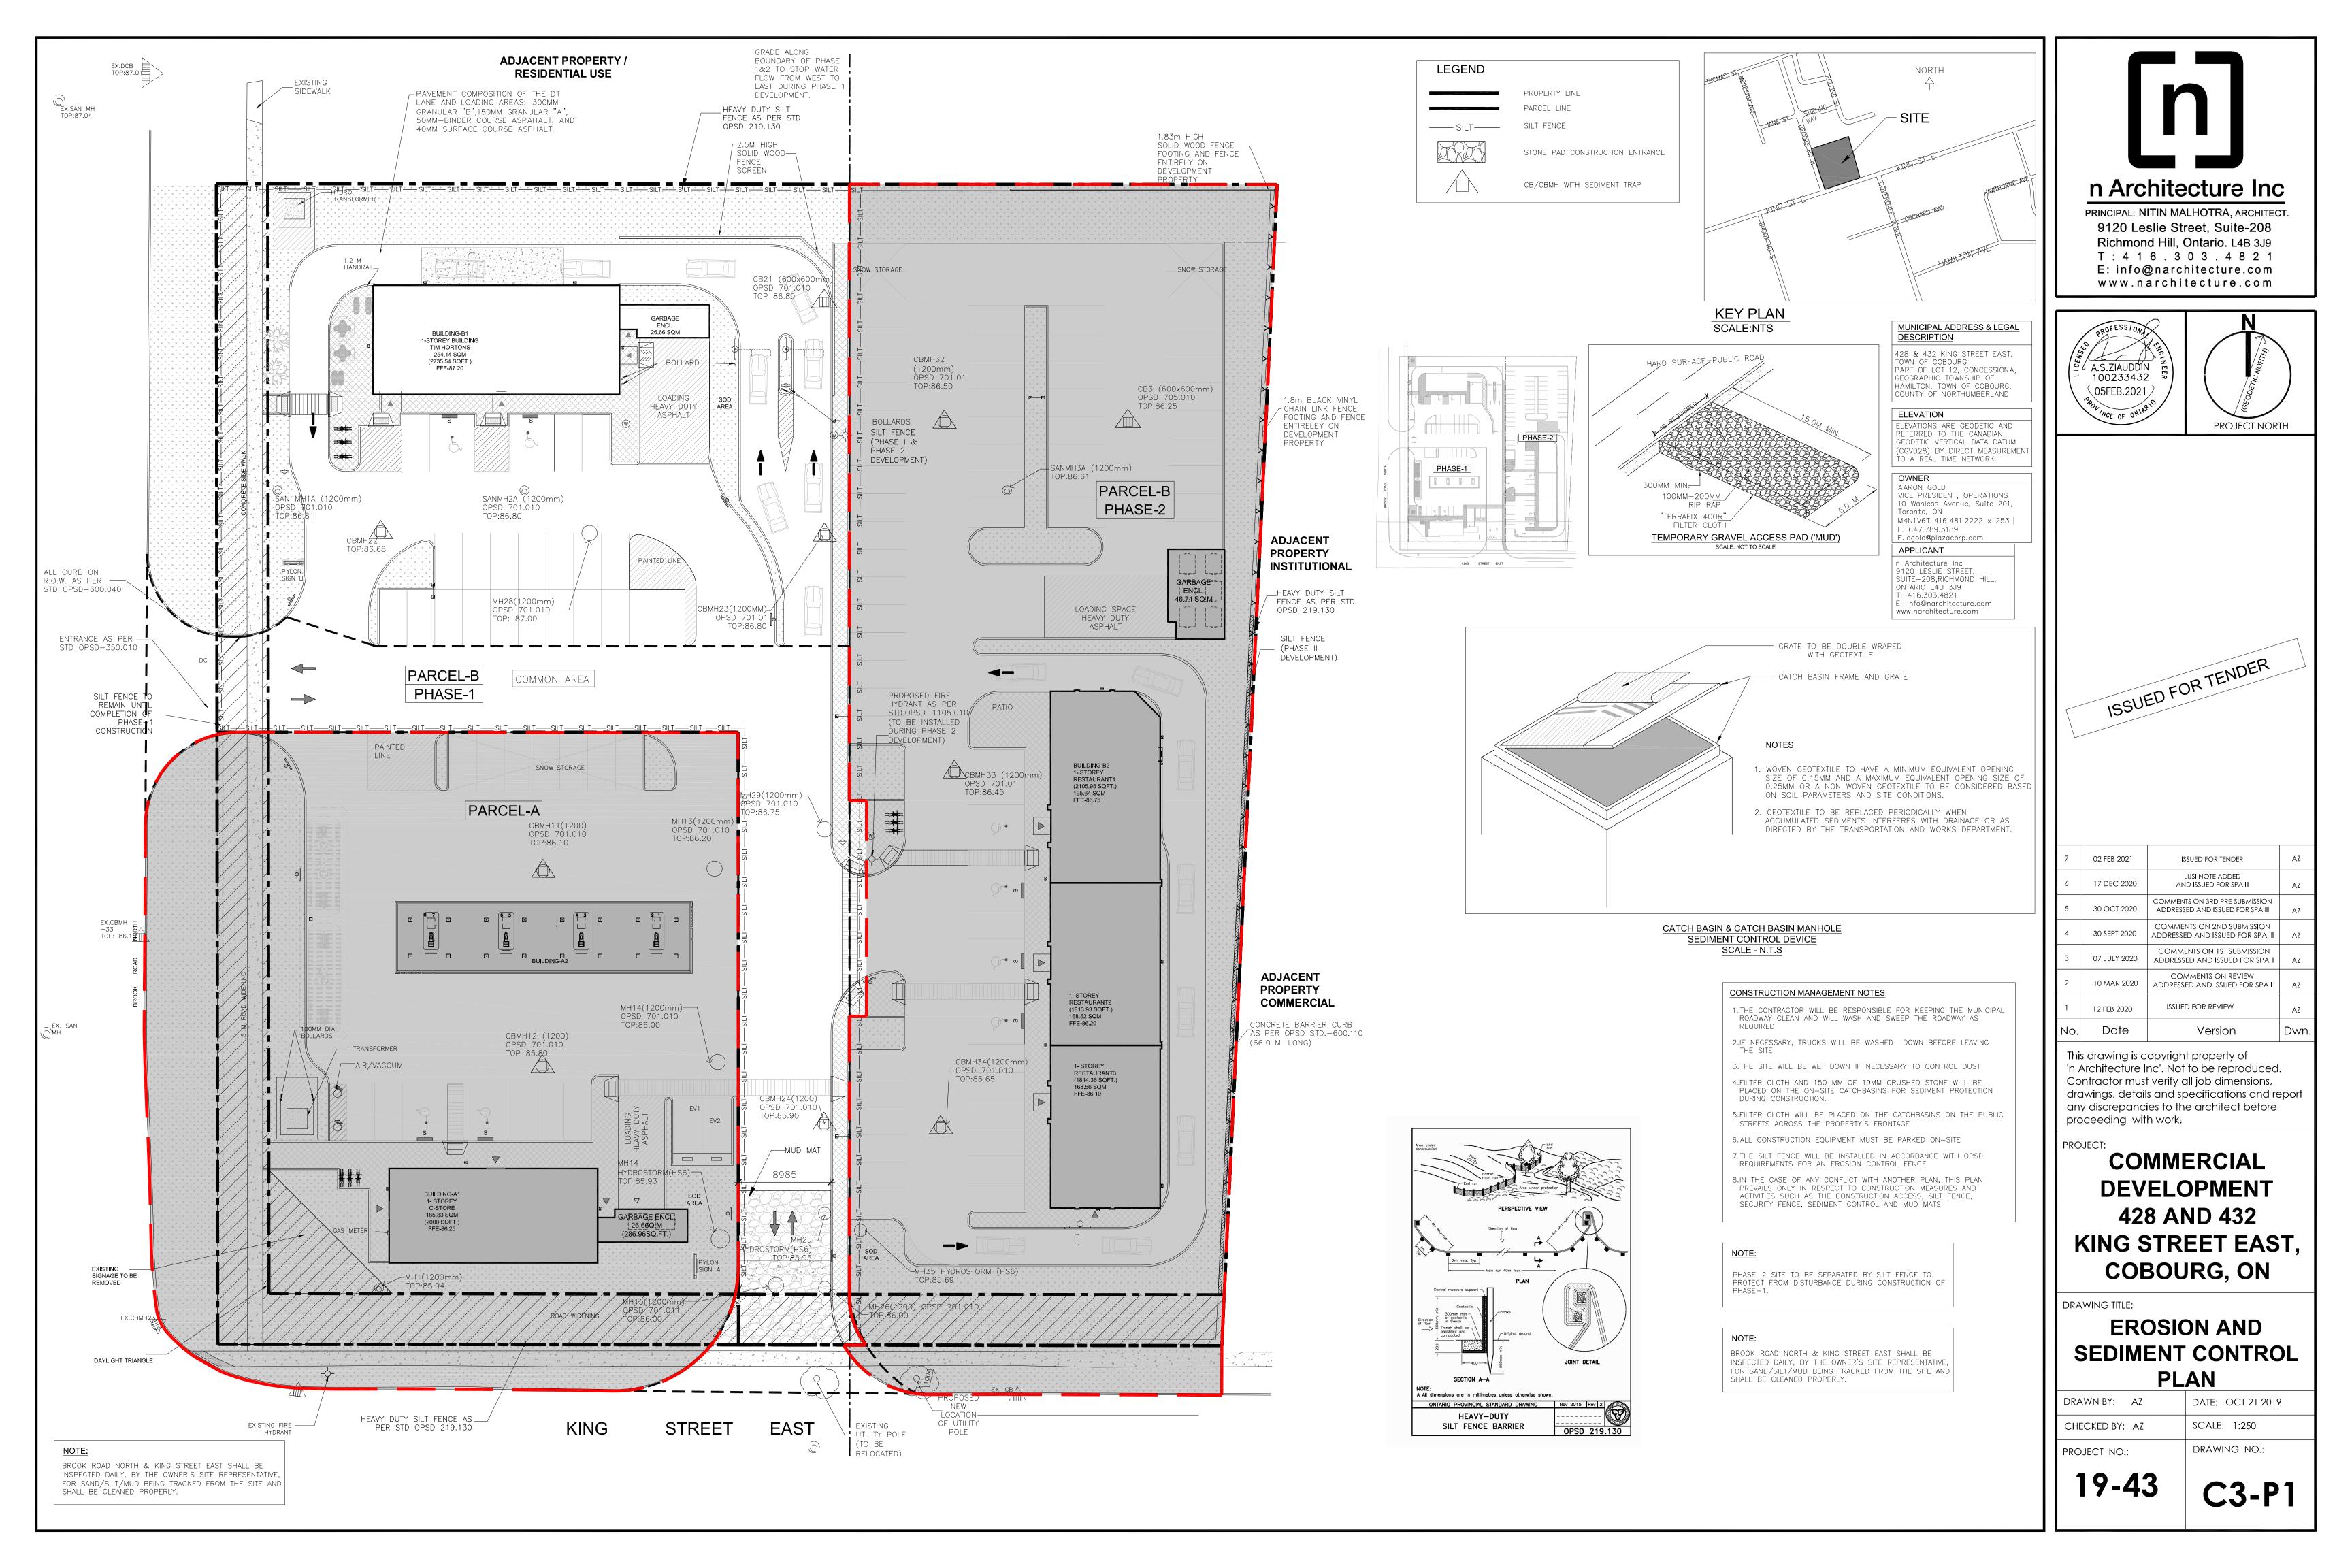

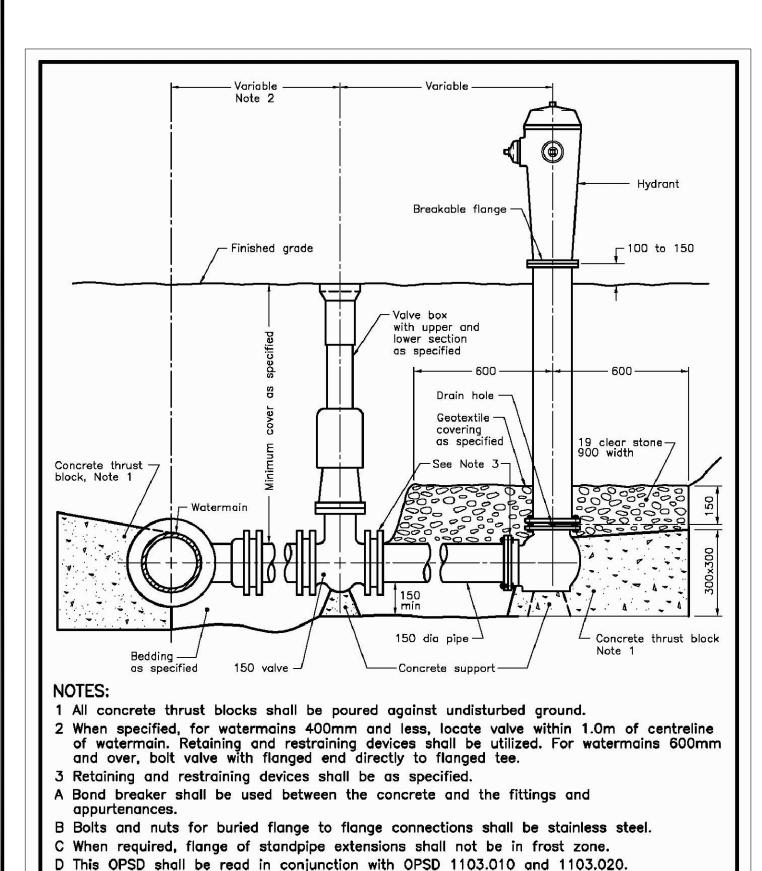

E Backfill material within 500mm of service box shall be native or imported, as specified.

Nov 2018 Rev 3 514


OPSD 1105.010


Tracer wire shall be installed as specified.


G All dimensions are in millimetres unless otherwise shown.

HYDRANT INSTALLATION

ONTARIO PROVINCIAL STANDARD DRAWING

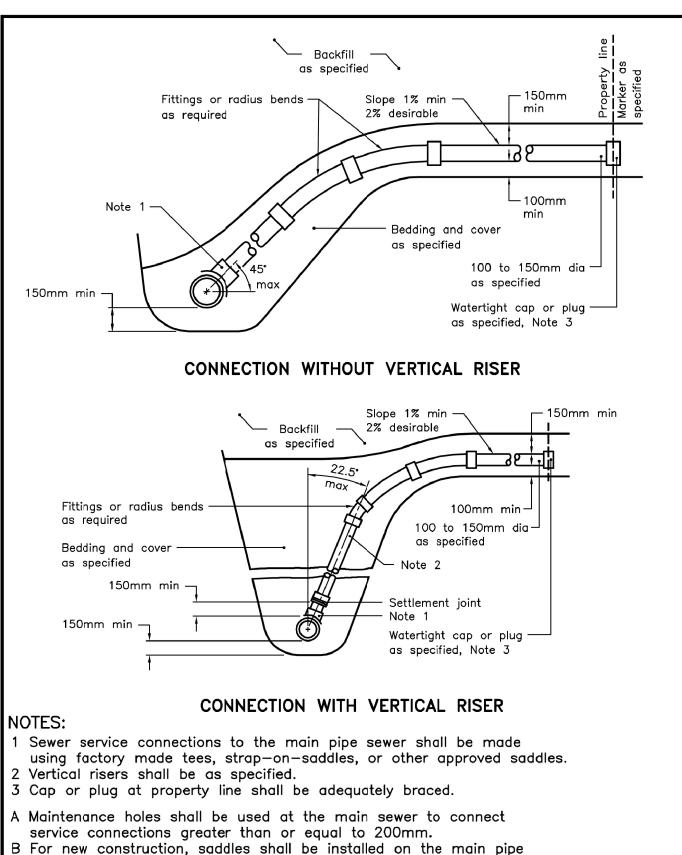

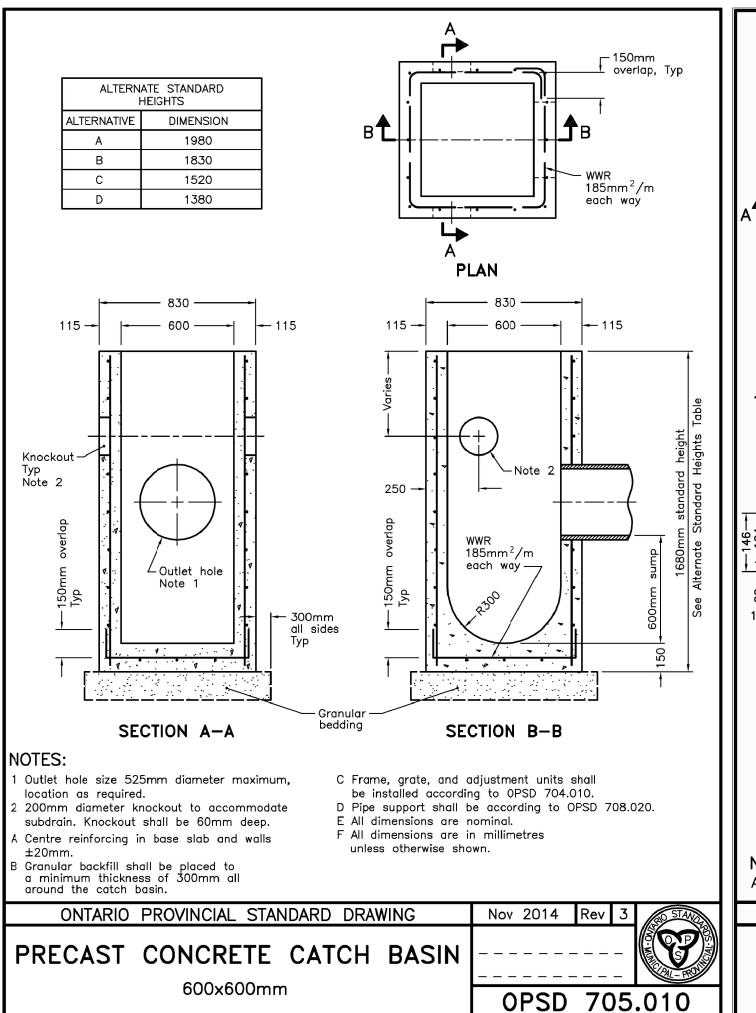

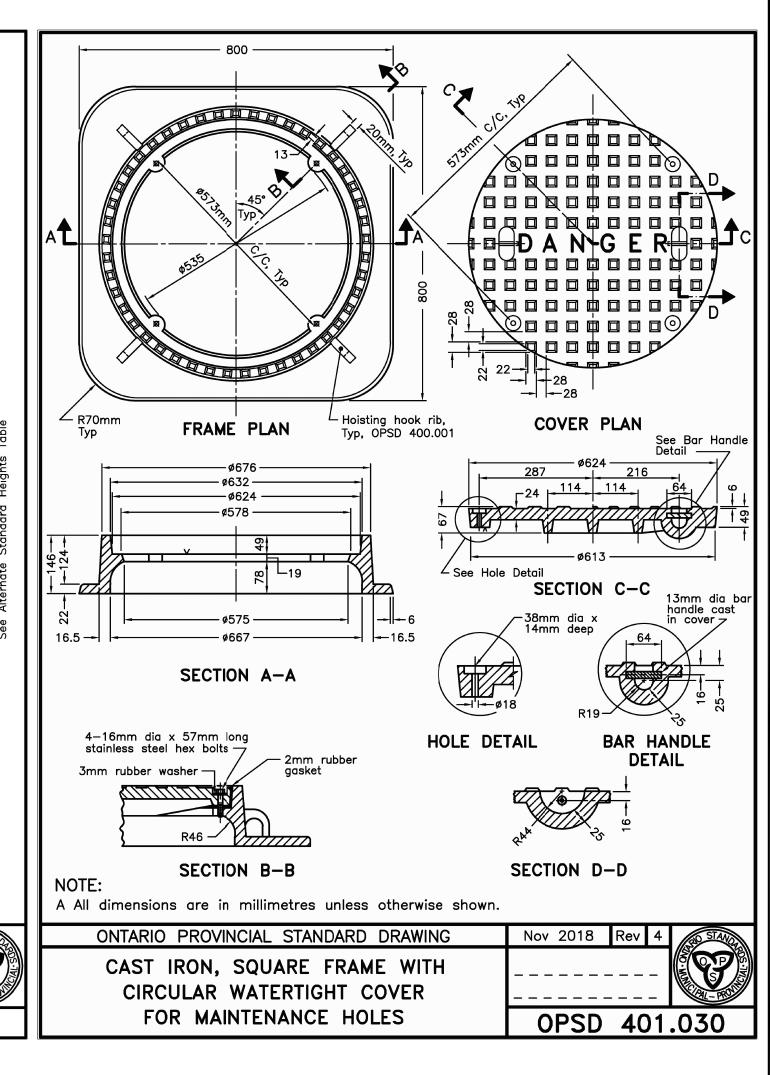

PAVEMENT LAYER (THICKNESS 695 MM)

BACK FILL

SECTION A-A

(CHAMBERMAXX SECTION)


SCALE: NTS

GL. 86.82

<u> ШПШПШПШГЕLE. 84.43</u>





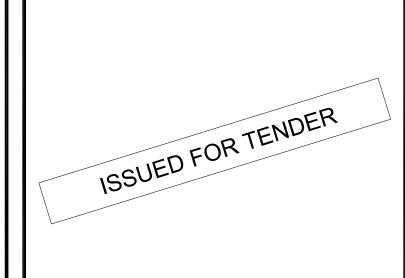

7	25 JAN 2020	ISSUED FOR TENDER	ΑZ			
6	17 DEC 2020	LUSI NOTE ADDED AND ISSUED FOR SPA III	ΑZ			
5	30 OCT 2020	COMMENTS ON 3RD PRE-SUBMISSION ADDRESSED AND ISSUED FOR SPA III	ΑZ			
4	30 SEPT 2020	COMMENTS ON 2ND SUBMISSION ADDRESSED AND ISSUED FOR SPA III	ΑZ			
3	07 JULY 2020	COMMENTS ON 1ST SUBMISSION ADDRESSED AND ISSUED FOR SPA II	ΑZ			
2	10 MAR 2020	COMMENTS ON REVIEW ADDRESSED AND ISSUED FOR SPAI	ΑZ			
1	12 FEB 2020	ISSUED FOR REVIEW	ΑZ			
o. Z	Date	Version	Dwn.			

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PROJECT:

COMMERCIAL DEVELOPMENT 428 AND 432 KING STREET EAST, COBOURG, ON


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DRAWN BY: AZ

STANDARD AND DETAILS


DATE: OCT 21 2019 SCALE: N.T.S CHECKED BY: AZ DRAWING NO .: PROJECT NO .:

C4

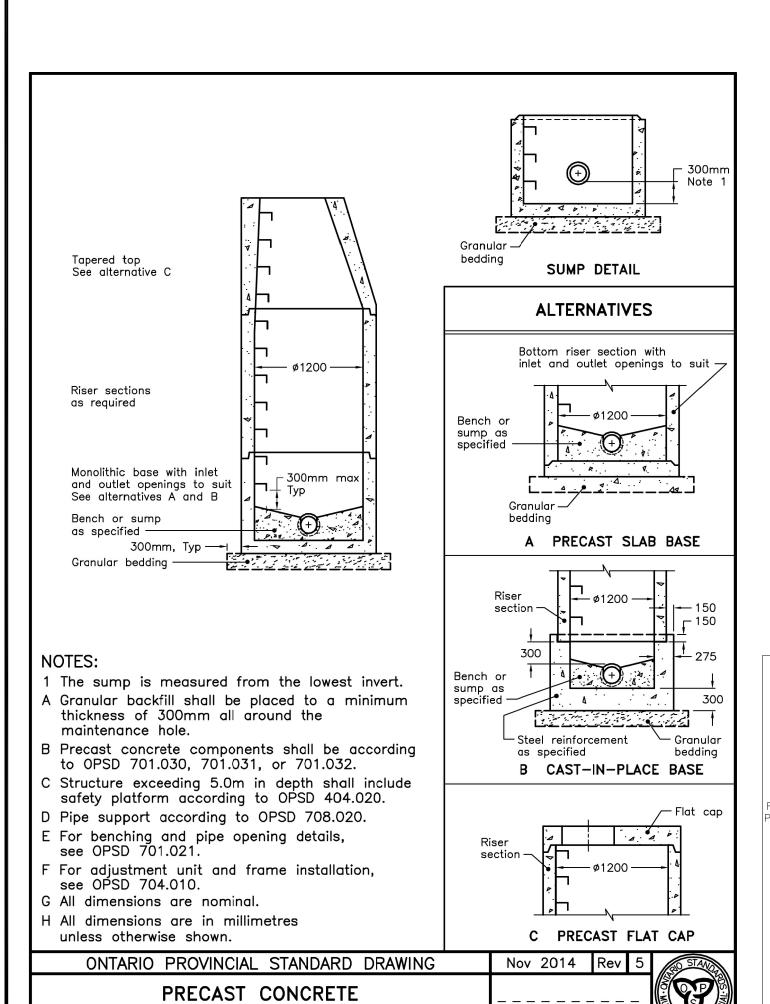


MAINTENANCE HOLE


1200mm DIAMETER

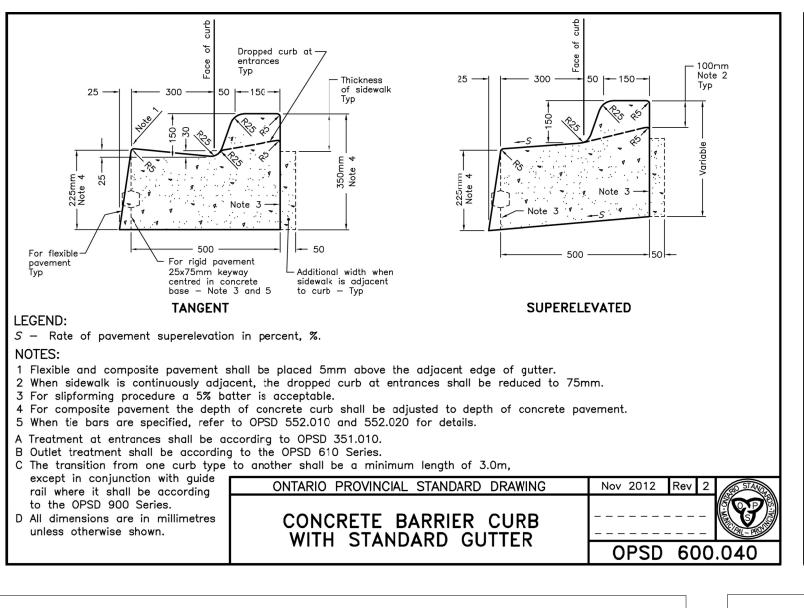


Nov 2016 Rev 3

OPSD 1006.010

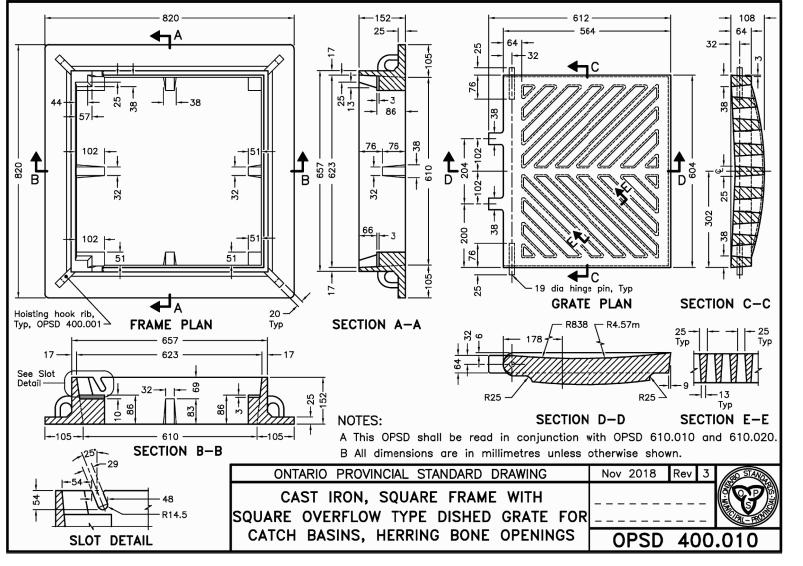

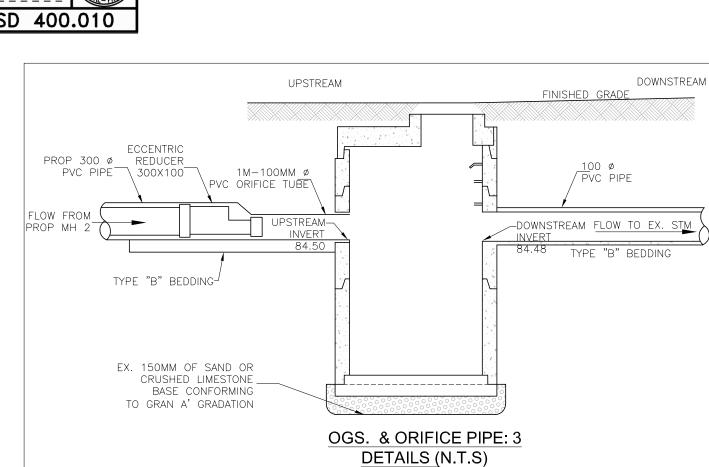

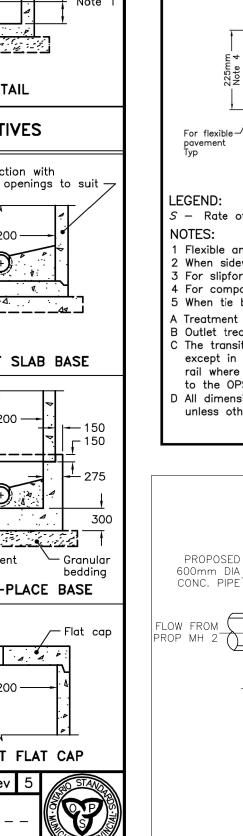

OPSD 701.010

before that pipe is laid.

Approved cut-in tool shall be used for field made connections.

All dimensions are in millimetres unless otherwise shown.

ONTARIO PROVINCIAL STANDARD DRAWING

SEWER SERVICE CONNECTIONS

FOR MAIN PIPE SEWER

