


TREE PROTECTION FENCING

TREE PROTECTION NOTES

- a. ALL EXISTING TREES WHICH ARE TO REMAIN SHALL BE FULLY PROTECTED WITH HOARDING ERECTED BEYOND THE DRIP LINE TO THE SATISFACTION OF THE RECREATION & PARKS DEPARTMENT PRIOR TO THE ISSUANCE OF THE BUILDING PERMIT. GROUPS OF TREES AND OTHER EXISTING YEGETATION TO BE PROTECTED WITH HOARDING AROUND THE ENTIRE AREA. AREAS WITHIN THE PROTECTIVE FENCING SHALL REMAIN UNDISTURBED AND SHALL NOT BE USED FOR THE STORAGE OF BUILDING MATERIALS OR EQUIPMENT.
- b. NO RIGGING CABLES SHALL BE WRAPPED AROUND OR INSTALLED IN THE TREES AND SURPLUS SOIL, EQUIPMENT, DEBRIS OR MATERIALS SHALL NOT BE PLACED OVER THE ROOT SYSTEMS OF THE TREES WITHIN THE PROTECTIVE FENCING. NO CONTAMINANTS WILL BE DUMPED OR FLUSHED WHERE FEEDER ROOTS OF TREES EXIST.
- C. THE DEVELOPER OR AGENTS SHALL TAKE EVERY PRECAUTION NECESSARY TO PREVENT DAMAGE TO THE VEGETATION TO
- d. WHERE LIMBS OF PORTIONS OF TREES ARE REMOVED TO ACCOMMODATE CONSTRUCTION, THEY WILL BE REMOVED IN ACCORDANCE WITH ACCEPTED ARBORICULTURAL PRACTICE.
- e. WHERE ROOT SYSTEMS OF PROTECTED TREES ADJACENT TO CONSTRUCTION ARE EXPOSE OR DAMAGED THEY SHALL BE NEATLY TRIMMED AND THE AREA BACKFILLED WITH APPROPRIATE MATERIAL TO PREVENT DESICCATION.
- f. WHERE NECESSARY, VEGETATION WILL BE GIVEN AN OVERALL PRUNING TO RESTORE THE BALANCE BETWEEN ROOTS AND TOP GROWTH, OR TO RESTORE ITS APPEARANCE.
- g. TREES THAT HAVE DIED OR HAVE BEEN DAMAGED BEYOND REPAIR SHALL BE REMOVED AND REPLACED AT THE OWNERS EXPENSE WITH TREES OF A SIZE AND SPECIES APPROVED BY THE RECREATION & PARKS DEPARTMENT.
- h. IF GRADE AROUND TREES TO BE PROTECTED AREA TO CHANGE, THE OWNER SHALL BE REQUIRED TO TAKE PRECAUTIONS SUCH AS DRIVE WELLING, RETAINING WALLS, AND ROOT FEEDING TO THE SATISFACTION OF THE RECREATION & PARKS

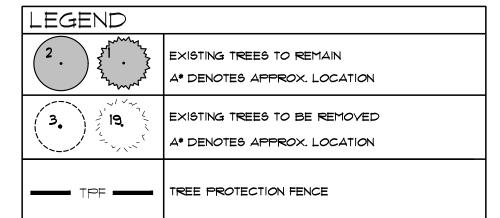

NOTE: SEE L2 FOR EXISTING TREE INVENTORY LIST

NOTE:
TREE PROTECTION SIGNAGE SHALL BE POSTED AS FOLLOWS:


PLASTIC 28cm x 43cm SPACED EVERY 15m OR CHANGE IN DIRECTION, OR SECTION LESS THAN 15m.
SIGN TEXT:

TOWN OF COBOURG TREE PROTECTION ZONE (TPZ)

NO GRADE CHANGES, TRENCHING, STORAGE OF MATERIALS OR EQUIPMENT, LIQUID DISPOSAL, HARD SURFACING OR VEHICULAR TRAFFIC ARE PERMITTED WITHIN THIS TREE PROTECTION ZONE (TPZ).

THE TREE PROTECTION BARRIER MUST NOT BE REMOVED WITHOUT AUTHORIZATION OF THE TOWN OF COBOURG.

FOR MORE INFORMATION, PLEASE CONTACT THE BUILDING AND PLANNING DEPARTMENT AT (905) 372-1005

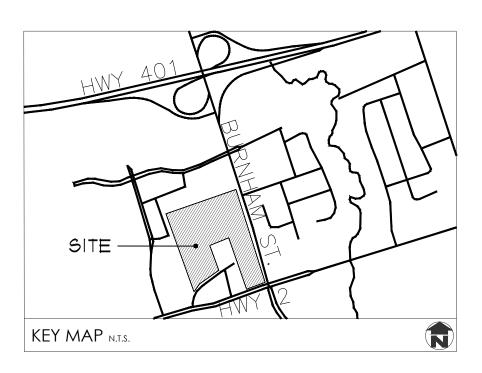

GENERAL NOTES

- 1. CONTRACTOR TO LOCATE ALL UNDERGROUND UTILITIES.
- 2. SITE PLAN INFORMATION AS PER SALTER PILON ARCHITECTS
- 3. TOPOGRAPHIC AND EXISTING CONDITIONS INFORMATION AS PER LEA CONSULTING LTD., DATED SEPTEMBER 10, 2018.





2 Jul.22.20 Issued for SPA resubmission 3
AWH
1. Jul.13.20 Re—issued for Permit
0. May.25.20 Issued for SPA resubmission 2
Mar.20.20 Issued for MOHLTC Working Drawing Review
CMH
2. Mar.13.20 Issued for SPA Resubmission
CMH
2. Feb.26.20 Issued for Coordination
CMH
3. Dec.23.19 Issued for Building Permit
CMH
4. Nov.26.19 Issued for 60% Contract Documents
CMH
5. Aug.28.19 Issued for 100% DD
CMH
6. Aug.12.19 Issued for SPA
CMH
6. Nov.30.18 For coordination
CMH
6. Added description
Dec. Aug. 28.19 Issued for SPA
CMH
6. Aug. 40.10.10 Issued for SPA
CMH
6. Aug. 40.10 Issued for SPA
CMH
6. Aug.

GPL LTC FACILITY & NCAM 555 COURTHOUSE ROAD TOWN OF COBOURG

Vegetation Management Plan



DRAWN BY:	DESIGNED BY:	APPROVED BY:
KLH	СМН	AWH
PROJECT NO.	SCALE:	DATE:
2018-36	1:750	October 26,2018
PLOTTED:	SHEET:	
July 22, 2020		L1

	NG TREE LIST				
NO.	SPECIES	D.B.H	CONDITION	STATUS	ADDITIONAL NOTE
1 4	Califa and the tr	15.0		To locate the second	Daw la i
14.	Celtis occidentalis	15cm 20cm	Good	To be removed	Boundary tree
2. 3.	Celtis occidentalis Celtis occidentalis	20cm	Good	To be preserved To be removed	
5. 4.	Celtis occidentalis	15cm	Good Fair		
<u>4.</u> 5 <i>A.</i>	Acer platanoides	35cm	Good	To be preserved	
<u>5Д.</u> 6Д.	'	35cm	G000	To be preserved	
<u>юд.</u> ПД.	Acer platanoides	35cm	+	To be preserved To be removed	
	Acer platanoides	35cm	Good		
8A.	Acer platanoides	15cm	Good	To be preserved	
9. 10.	Acer platanoides	15cm	Good	To be preserved	Tu a tu vele
11.	Acer platanoides Acer platanoides	40cm	Good Fair	To be preserved	Two trunks
12.	Acer platanoides	40cm	Fair	To be preserved	Trunk wound
13.	'	45cm		To be preserved	Leaf scorch
14.	Acer platanoides Acer platanoides	45cm	Good	To be preserved	On adjacent property
15.	Acer platanoides	45cm	Good	To be preserved	On adjacent property
16. 16.	'	45cm	Good	To be preserved	On adjacent property
17.	Acer platanoides Acer platanoides	45cm	Good	To be preserved	On adjacent property
1 1. 18.	1	40cm	Good	To be preserved To be removed	On adjacent property
	Acer platanoides	40cm	Good		Boundary tree, leaf scorch
19.	Malus rosaceae	50cm	Good	To be removed	Leaning
2 <i>Ø.</i>	Acer platanoides		Good	To be removed	Black spot
21.	Acer rubrum	35cm	Good	To be removed	To a Amounts
22 <i>A.</i>	Juglans nigra	25cm	Good	To be removed	Two trunks
23.	Fraxinus sp.	15cm	Good	To be preserved	Trunk damage
24.	Fraxinus sp.	35cm	Good	To be preserved	Boundary tree
25.	Acer saccharinum	+65cm	Good	To be preserved	Co-dominate stems within bark
26. 2 7	Acer saccharinum	+65cm	Good	To be preserved	Co-dominate stems within bark
27 <i>.</i>	Tilia cordata	+65cm	Good	To be preserved	
2 <i>8.</i>	Tilia cordata	45cm	Good	To be preserved	
29.	Tilia cordata	45cm	Good	To be preserved	
3 <i>0.</i>	Tilia cordata	45cm	Good	To be preserved	
31.	Tilia cordata	55cm	Good	To be preserved	
32 <i>A.</i>	Pinus nigra	45cm	Good	To be preserved	
33 <i>A.</i>	Pinus nigra	45cm	Good	To be preserved	
34 <i>A.</i>	Pinus nigra	45cm	Good	To be preserved	
35 <i>.</i>	Acer rubrum	25cm	Good	To be preserved	
36.	Acer rubrum	20cm	Fair	To be preserved	Trunk wounds
37 <i>.</i>	Acer rubrum	15cm	Good	To be preserved	
3 <i>8.</i>	Acer rubrum	15cm	Good	To be preserved	
39.	Acer rubrum	30cm	Good	To be preserved	
40.	Acer platanoides	45cm	Good	To be preserved	
41.	Acer platanoides	35cm	Good	To be preserved	
42.	Acer rubrum	25cm	Fair	To be preserved	
43.	Malus rosaceae	25cm	Fair	to be removed	On adjacent property
44.	Malus rosaceae	25cm	Fair	To be removed	On adjacent property
45.	Acer rubrum	25cm	Good	To be preserved	
46.	Acer rubrum	25cm	Good	To be preserved	Co-dominant stems within bark
47.	Acer rubrum	40cm	Good	To be preserved	
48.	Acer rubrum	25cm	Fair	To be removed	On adjacent property
49.	Betula papyrifera	25cm	Good	To be removed	
		^=	1 - 1	To be removed	
	Betula papyrifera	25cm	Good		
	Betula papyrifera Acer rubrum	25cm	G000 G000	To be preserved	
51. 52.	· · · •	25cm	+	To be preserved To be removed	
51. 52.	Acer rubrum	25cm	Good	· ·	
51. 52. 53. 54.	Acer rubrum Malus rosaceae Acer rubrum Acer rubrum	25cm 25cm 15cm 40cm	Good Fair	To be removed To be preserved To be removed	
51. 52. 53. 54.	Acer rubrum Malus rosaceae Acer rubrum Acer rubrum Malus rosaceae	25cm 25cm 15cm 40cm 25cm	Good Fair Good	To be removed To be preserved	
51. 52. 53. 54.	Acer rubrum Malus rosaceae Acer rubrum Acer rubrum	25cm 25cm 15cm 40cm	Good Fair Good Fair	To be removed To be preserved To be removed	Leaning
51. 52. 53. 54. 55. 56 <i>A</i> . 57.	Acer rubrum Malus rosaceae Acer rubrum Acer rubrum Malus rosaceae Pinus nigra Malus rosaceae	25cm 25cm 15cm 40cm 25cm 35cm	Good Fair Good Fair Good	To be removed To be preserved To be removed To be removed To be removed To be removed	Leaning
51. 52. 53. 54. 55. 56A. 57.	Acer rubrum Malus rosaceae Acer rubrum Acer rubrum Malus rosaceae Pinus nigra Malus rosaceae Pinus nigra	25cm 25cm 15cm 40cm 25cm 35cm 15cm	Good Fair Good Fair Good Fair	To be removed To be preserved To be removed To be removed To be removed	Leaning
51. 52. 53. 54. 55. 56A. 57.	Acer rubrum Malus rosaceae Acer rubrum Acer rubrum Malus rosaceae Pinus nigra Malus rosaceae Pinus nigra Pinus nigra Pinus nigra	25cm 25cm 15cm 40cm 25cm 35cm 15cm 35cm	Good Fair Good Fair Good Fair Good	To be removed To be preserved To be removed	Leaning
51. 52. 53. 54. 55. 56A. 57. 58A. 59A.	Acer rubrum Malus rosaceae Acer rubrum Acer rubrum Malus rosaceae Pinus nigra Malus rosaceae Pinus nigra Pinus nigra Pinus nigra Pinus nigra	25cm 25cm 15cm 40cm 25cm 35cm 15cm 35cm 35cm 35cm	Good Fair Good Fair Good Fair Good Good	To be removed To be preserved To be removed	Leaning
51. 52. 53. 54. 55. 56. 57. 58. 59. 69. 61.	Acer rubrum Malus rosaceae Acer rubrum Acer rubrum Malus rosaceae Pinus nigra Malus rosaceae Pinus nigra Pinus nigra Pinus nigra Pinus nigra Pinus nigra Pinus nigra	25cm 25cm 15cm 40cm 25cm 35cm 35cm 35cm 35cm 35cm	Good Fair Good Fair Good Fair Good Good Good	To be removed To be preserved To be removed	Leaning
51. 52. 53. 54. 55. 56A. 57. 58A. 59A. 60A.	Acer rubrum Malus rosaceae Acer rubrum Acer rubrum Malus rosaceae Pinus nigra Malus rosaceae Pinus nigra Pinus nigra Pinus nigra Pinus nigra	25cm 25cm 15cm 40cm 25cm 35cm 15cm 35cm 35cm 35cm	Good Fair Good Fair Good Fair Good Good Good	To be removed To be preserved To be removed To be preserved To be removed	Leaning
51. 52. 53. 54. 55. 56. 57. 58. 59. 60. 61.	Acer rubrum Malus rosaceae Acer rubrum Acer rubrum Malus rosaceae Pinus nigra Malus rosaceae Pinus nigra Pinus nigra Pinus nigra Pinus nigra Pinus nigra Pinus nigra	25cm 25cm 15cm 40cm 25cm 35cm 35cm 35cm 35cm 35cm 35cm 35cm	Good Fair Good Fair Good Fair Good Good Good Fair	To be removed To be preserved To be removed To be preserved To be preserved	Leaning
51. 52. 53. 54. 55. 56A. 57. 58A. 69A. 61A. 62A.	Acer rubrum Malus rosaceae Acer rubrum Acer rubrum Malus rosaceae Pinus nigra Malus rosaceae Pinus nigra	25cm 25cm 15cm 40cm 25cm 35cm 15cm 35cm 35cm 35cm 25cm	Good Fair Good Fair Good Fair Good Good Good Fair Good	To be removed To be preserved To be removed To be preserved To be preserved To be preserved To be preserved	Leaning
51. 52. 53. 54. 55. 56A. 57. 58A. 59A. 60A. 61A. 62A. 63A.	Acer rubrum Malus rosaceae Acer rubrum Acer rubrum Malus rosaceae Pinus nigra Malus rosaceae Pinus nigra	25cm 25cm 15cm 40cm 25cm 35cm 35cm 35cm 35cm 35cm 35cm 35cm	Good Fair Good Fair Good Fair Good Good Good Fair Good Good Good Good Good Good	To be removed To be preserved To be removed To be preserved	Leaning
51. 52. 53. 54. 55. 56A. 57. 58A. 69A. 61A. 62A. 63A. 64A.	Acer rubrum Malus rosaceae Acer rubrum Acer rubrum Malus rosaceae Pinus nigra Malus rosaceae Pinus nigra	25cm 25cm 15cm 40cm 25cm 35cm 35cm 35cm 35cm 35cm 35cm 40cm	Good Fair Good Fair Good Fair Good Good Good Fair Good Good Good Good Good Good Good	To be removed To be preserved To be removed To be preserved	Leaning
51. 52. 53. 54. 55. 56A. 57. 58A. 69A. 61A. 62A. 63A. 64A. 65A.	Acer rubrum Malus rosaceae Acer rubrum Acer rubrum Malus rosaceae Pinus nigra Malus rosaceae Pinus nigra	25cm 25cm 15cm 40cm 25cm 35cm 35cm 35cm 35cm 35cm 35cm 40cm 45cm	Good Fair Good Fair Good Fair Good Good Good Good Good Good Good Goo	To be removed To be preserved To be removed To be preserved	Leaning
51. 52. 53. 54. 55. 56A. 57. 58A. 69A. 61A. 62A. 63A. 64A. 65A. 65A.	Acer rubrum Malus rosaceae Acer rubrum Acer rubrum Malus rosaceae Pinus nigra Malus rosaceae Pinus nigra	25cm 25cm 15cm 40cm 25cm 35cm 35cm 35cm 35cm 35cm 35cm 40cm 45cm	Good Fair Good Fair Good Fair Good Good Good Fair Good Good Fair Good Good Fair	To be removed To be preserved To be removed To be preserved	Leaning
51. 52. 53. 54. 55. 56A. 57A. 60A. 61A. 62A. 63A. 64A. 65A. 67A.	Acer rubrum Malus rosaceae Acer rubrum Acer rubrum Malus rosaceae Pinus nigra Malus rosaceae Pinus nigra	25cm 25cm 15cm 40cm 25cm 35cm 35cm 35cm 35cm 35cm 35cm 40cm 45cm 45cm	Good Fair Good Fair Good Fair Good Good Good Good Good Good Good Goo	To be removed To be preserved To be removed To be preserved	Leaning
51. 52. 53. 54. 55. 56A. 57A. 69A. 61A. 63A. 65A. 65A. 65A. 67A. 68A.	Acer rubrum Malus rosaceae Acer rubrum Acer rubrum Malus rosaceae Pinus nigra Malus rosaceae Pinus nigra	25cm 25cm 15cm 40cm 25cm 35cm 35cm 35cm 35cm 35cm 35cm 40cm 45cm 45cm 45cm 55cm	Good Fair Good Fair Good Fair Good Good Good Fair Good Good Fair Good Good Good Good Good Good Good Goo	To be removed To be preserved To be removed To be removed To be removed To be removed To be preserved	Leaning In planter
51. 52. 53. 54. 55. 56A. 57. 58A. 69A. 61A. 62A. 63A. 64A. 65A. 65A. 67A. 68A.	Acer rubrum Malus rosaceae Acer rubrum Acer rubrum Malus rosaceae Pinus nigra Malus rosaceae Pinus nigra	25cm 25cm 15cm 40cm 25cm 35cm 35cm 35cm 35cm 35cm 35cm 40cm 45cm 45cm 45cm 45cm 45cm 45cm	Good Fair Good Fair Good Fair Good Good Good Good Good Good Good Goo	To be removed To be preserved To be removed To be removed To be removed To be removed To be preserved To be removed To be removed To be removed To be removed	
51. 52. 53. 54. 55. 56A. 57. 58A. 69A. 61A. 63A. 65A. 65A. 65A. 67A. 68A.	Acer rubrum Malus rosaceae Acer rubrum Acer rubrum Malus rosaceae Pinus nigra Malus rosaceae Pinus nigra	25cm 25cm 15cm 40cm 25cm 35cm 35cm 35cm 35cm 35cm 35cm 40cm 45cm 45cm 45cm 45cm 35cm	Good Fair Good Fair Good Fair Good Good Good Good Good Good Good Goo	To be removed To be preserved To be removed To be removed To be removed To be removed To be preserved To be removed To be preserved To be removed	
51. 52. 53. 54. 55. 56A. 57. 58A. 69A. 61A. 63A. 64A. 65A. 66A. 67A. 68A. 69. 10A.	Acer rubrum Malus rosaceae Acer rubrum Acer rubrum Malus rosaceae Pinus nigra Malus rosaceae Pinus nigra Picea pungens Malus rosaceae Ulmus sp. Gleditsia triacanthos Acer platanoides	25cm 25cm 15cm 40cm 25cm 35cm 35cm 35cm 35cm 35cm 35cm 40cm 45cm 45cm 45cm 45cm 35cm	Good Fair Good Fair Good Good Good Good Good Good Good Goo	To be removed To be preserved To be removed To be removed To be removed To be removed To be preserved To be removed To be removed To be removed To be removed To be preserved To be preserved To be preserved	In planter
51. 52. 53. 54. 55. 56A. 57. 58A. 69A. 61A. 62A. 63A. 65A. 65A. 65A. 67A. 61A. 10A. 11. 12A.	Acer rubrum Malus rosaceae Acer rubrum Acer rubrum Malus rosaceae Pinus nigra Malus rosaceae Pinus nigra Picea pungens Malus rosaceae Ulmus sp. Gleditsia triacanthos Acer platanoides Amelanchier canadensis	25cm 25cm 15cm 40cm 25cm 35cm 35cm 35cm 35cm 35cm 35cm 40cm 45cm 45cm 45cm 35cm 45cm	Good Fair Good Fair Good Fair Good Good Good Good Good Good Good Goo	To be removed To be preserved To be removed To be removed To be removed To be removed To be preserved To be removed To be preserved	In planter Clump
51. 52. 53. 54. 55. 56A. 57. 58A. 69A. 61A. 63A. 64A. 65A. 66A. 67A. 68A. 61A. 10A. 11. 12A. 13.	Acer rubrum Malus rosaceae Acer rubrum Acer rubrum Malus rosaceae Pinus nigra	25cm 25cm 15cm 40cm 25cm 35cm 35cm 35cm 35cm 35cm 35cm 40cm 45cm 45cm 45cm 35cm 45cm 45cm 45cm 55cm	Good Fair Good Fair Good Fair Good Good Good Good Good Good Good Goo	To be removed To be preserved To be removed To be removed To be removed To be removed To be preserved To be removed To be preserved	In planter Clump
51. 52. 53. 54. 55. 56. 58. 58. 69. 61. 62. 63. 64. 63. 64. 65. 67. 68. 67. 68. 61. 61. 61. 62. 63. 64. 63. 64. 64. 65. 67. 67. 68. 67. 67. 67. 67. 67. 67. 67. 67	Acer rubrum Malus rosaceae Acer rubrum Acer rubrum Malus rosaceae Pinus nigra Malus rosaceae Pinus nigra Picea pungens Malus rosaceae Ulmus sp. Gleditsia triacanthos Acer platanoides Amelanchier canadensis Thuja occidentalis Malus rosaceae	25cm 25cm 15cm 40cm 25cm 35cm 35cm 35cm 35cm 35cm 35cm 40cm 45cm 45cm 45cm 45cm 45cm 45cm 45cm 45	Good Fair Good Fair Good Fair Good Good Good Good Good Good Good Goo	To be removed To be preserved To be removed To be preserved	In planter Clump
51. 52. 53. 54. 55. 56A. 57. 58A. 69A. 65A. 65A. 65A. 65A. 61A. 65A. 61A. 10A. 11. 12A. 13. 14.	Acer rubrum Malus rosaceae Acer rubrum Acer rubrum Malus rosaceae Pinus nigra	25cm 25cm 15cm 40cm 25cm 35cm 35cm 35cm 35cm 35cm 35cm 40cm 45cm 45cm 45cm 35cm 10-25cm 50cm 20cm 20cm	Good Fair Good Fair Good Fair Good Good Good Good Good Good Good Goo	To be removed To be preserved To be removed To be preserved	In planter Clump
51. 52. 53. 54. 55. 56. 56. 56. 58. 69. 61. 62. 63. 64. 66. 67. 68. 69. 11. 12. 13. 14. 15.	Acer rubrum Malus rosaceae Acer rubrum Acer rubrum Malus rosaceae Pinus nigra	25cm 25cm 15cm 40cm 25cm 35cm 35cm 35cm 35cm 35cm 35cm 40cm 45cm 45cm 45cm 45cm 35cm 25cm 35cm 25cm 35cm 26cm 26cm 27cm 35cm	Good Fair Good Fair Good Fair Good Good Good Good Good Good Good Goo	To be removed To be preserved To be preserved To be preserved To be preserved To be removed To be preserved	In planter Clump
51. 52. 53. 54. 55. 56A. 57. 58A. 69A. 61A. 65A. 65A. 65A. 67A. 68A. 69. 11. 12A. 13. 14. 15. 16.	Acer rubrum Malus rosaceae Acer rubrum Acer rubrum Malus rosaceae Pinus nigra	25cm 25cm 15cm 40cm 25cm 35cm 35cm 35cm 35cm 35cm 35cm 35cm 40cm 45cm 45cm 45cm 45cm 55cm 35cm 40cm 45cm 20cm 20cm 20cm 20cm 35cm	Good Fair Good Fair Good Fair Good Good Good Good Good Good Good Goo	To be removed To be preserved To be preserved To be preserved To be preserved To be removed To be removed To be preserved To be removed To be preserved	In planter Clump
51. 52. 53. 54. 55. 56A. 57. 58A. 69A. 61A. 63A. 64A. 65A. 64A. 61A. 11. 12A. 11. 12A. 13. 14. 15.	Acer rubrum Malus rosaceae Acer rubrum Acer rubrum Malus rosaceae Pinus nigra Malus rosaceae Pinus nigra Pinus nig	25cm 25cm 15cm 40cm 25cm 35cm 35cm 35cm 35cm 35cm 35cm 40cm 45cm 45cm 45cm 35cm 45cm 25cm 35cm 25cm 25cm 35cm 25cm	Good Fair Good Fair Good Fair Good Good Good Good Good Good Good Goo	To be removed To be preserved To be removed To be preserved	In planter Clump
51. 52. 53. 54. 55. 56A. 57. 58A. 59A. 61A. 63A. 65A. 65A. 65A. 61A. 10A. 11. 12A. 11. 12A. 15. 16. 17. 18. 19. 18.	Acer rubrum Malus rosaceae Acer rubrum Acer rubrum Malus rosaceae Pinus nigra	25cm 25cm 15cm 40cm 25cm 35cm 35cm 35cm 35cm 35cm 35cm 35cm 40cm 45cm 45cm 45cm 45cm 45cm 45cm 25cm 35cm 40cm 45cm 25cm 35cm 40cm 45cm 45cm 45cm 45cm 45cm 45cm 45cm 45	Good Fair Good Fair Good Fair Good Good Good Good Good Good Good Goo	To be removed To be preserved To be removed To be preserved	In planter Clump
51. 52. 53. 54. 55. 56A. 57. 58A. 69A. 61A. 63A. 64A. 65A. 66A. 61A. 11. 12A. 11. 12A. 13. 14. 15. 16. 17. 18. 19. 180A.	Acer rubrum Malus rosaceae Acer rubrum Acer rubrum Malus rosaceae Pinus nigra	25cm 25cm 15cm 40cm 25cm 35cm 35cm 35cm 35cm 35cm 35cm 35cm 40cm 45cm 45cm 45cm 45cm 55cm 25cm 25cm 25cm 25cm 35cm 45cm 25cm 25cm 25cm 25cm	Good Fair Good Fair Good Fair Good Good Good Good Good Good Good Goo	To be removed To be preserved To be preserved To be preserved To be preserved To be removed To be preserved To be removed To be preserved	In planter Clump
51. 52. 53. 54. 55. 56A. 57. 58A. 69A. 66A. 66A. 66A. 66A. 67A. 11. 12A. 13. 14. 15. 16. 17. 18. 19. 80A. 81.	Acer rubrum Malus rosaceae Acer rubrum Acer rubrum Malus rosaceae Pinus nigra	25cm 25cm 15cm 40cm 25cm 35cm 35cm 35cm 35cm 35cm 35cm 35cm 40cm 45cm 45cm 45cm 45cm 35cm 25cm 25cm 35cm 40cm 45cm 35cm 45cm 45cm 35cm 45cm 45cm 45cm 45cm 45cm 45cm 45cm 4	Good Fair Good Fair Good Fair Good Good Good Good Good Good Good Goo	To be removed To be preserved To be preserved To be preserved To be preserved To be removed To be preserved	In planter Clump
51. 52. 53. 54. 55. 55. 56A. 57. 58A. 69A. 64A. 64A. 66A. 66A. 67A. 11. 12A. 13. 14. 15. 16. 17. 18. 19. 80A. 81.	Acer rubrum Malus rosaceae Acer rubrum Acer rubrum Malus rosaceae Pinus nigra	25cm 25cm 15cm 40cm 25cm 35cm 35cm 35cm 35cm 35cm 35cm 35cm 40cm 45cm 45cm 45cm 45cm 45cm 25cm 35cm 25cm 35cm 45cm 35cm 45cm 45cm 45cm 45cm 45cm 45cm 45cm 4	Good Fair Good Fair Good Fair Good Good Good Good Good Good Good Goo	To be removed To be preserved To be removed To be removed To be removed To be removed To be preserved To be preserved To be preserved To be preserved To be removed To be preserved To be preserved To be removed To be preserved	In planter Clump
51. 52. 53. 54. 55. 56. 56. 57. 58. 60. 61. 62. 63. 64. 65. 64. 66. 67. 11. 12. 13. 14. 15. 16. 17. 18. 19. 80. 81. 82. 83.	Acer rubrum Malus rosaceae Acer rubrum Acer rubrum Malus rosaceae Pinus nigra Picea pungens Malus rosaceae Ulmus sp. Gleditsia triacanthos Acer platanoides Amelanchier canadensis Thuja occidentalis Malus rosaceae Malus rosaceae Malus rosaceae Malus rosaceae Malus rosaceae Malus rosaceae Acer saccharinum	25cm 25cm 15cm 40cm 25cm 35cm 35cm 35cm 35cm 35cm 35cm 35cm 40cm 45cm 45cm 45cm 35cm 25cm 35cm 45cm 35cm 45cm 35cm 45cm 35cm 45cm 35cm 45cm 45cm 35cm 45cm 45cm 35cm 45cm 45cm 35cm 45cm 35cm 45cm 35cm 465cm 35cm 465cm 35cm 465cm 35cm 465cm 35cm 36cm 20cm 20cm 20cm 20cm 20cm 20cm 20cm 20	Good Fair Good Fair Good Fair Good Good Good Good Good Good Good Goo	To be removed To be preserved To be preserved To be preserved To be removed To be removed To be preserved To be removed To be preserved To be preserved	In planter Clump 30% dead
50. 51. 52. 53. 54. 55. 56. 56. 57. 58. 60. 61. 62. 63. 64. 65. 64. 66. 70. 71. 72. 73. 74. 75. 76. 71. 78. 79. 80. 81. 82. 83. 84. 85.	Acer rubrum Malus rosaceae Acer rubrum Acer rubrum Malus rosaceae Pinus nigra	25cm 25cm 15cm 40cm 25cm 35cm 35cm 35cm 35cm 35cm 35cm 35cm 40cm 45cm 45cm 45cm 45cm 45cm 25cm 35cm 25cm 35cm 45cm 35cm 45cm 45cm 45cm 45cm 45cm 45cm 45cm 4	Good Fair Good Fair Good Fair Good Good Good Good Good Good Good Goo	To be removed To be preserved To be removed To be removed To be removed To be removed To be preserved To be preserved To be preserved To be preserved To be removed To be preserved To be preserved To be removed To be preserved	In planter Clump

<i>O.</i>	SPECIES	D.B.H	CONDITION	STATUS	ADDITIONAL NOTE
37.	Ulmus pumila	+65cm	Fair	To be preserved	40% dead, trunk damage
38	Acer platanoides	45cm	Good	To be preserved	Co-dominant stems within bark
39.	Ulmus pumila	+65cm	Fair	To be preserved	Trunk damage
<i>90.</i>	Acer saccharinum	20cm	Fair	To be preserved	
91.	Acer saccharinum	20cm	Good	To be preserved	
9 2.	Malus rosaceae	15cm	Good	To be preserved	
93.	Gleditsia triacanthos	25cm	Good	To be preserved	
94 <i>A.</i>	Pinus glauca	20cm	Fair	To be preserved	Scale on lower 30%
95.	Malus rosaceae	15cm	Good	To be preserved	
96.	Malus rosaceae	15cm	Good	To be preserved	
97.	Gleditsia triacanthos	25cm	Good	To be preserved	
98.	Acer saccharum	25cm	Good	To be preserved	
99.	Jugane nigra	+65cm	Good	To be preserved	<u> </u>
100.	Acer saccharum	25cm	Fair	To be preserved	Trunk wounds
101.	Malus rosaceae	15cm	Good	To be preserved	
102.	Malus rosaceae	15cm	Good	To be preserved	
103A.	Picea glauca	15cm	Good	To be preserved	<u> </u>
104.	Quercus rubrum	15cm	Good	To be removed	In construction zone
105.	Nyssa sylvatica	15cm	Good	To be preserved	
106.	Gingko biloba	15cm	Good	To be preserved	
107.	Gingko biloba	20cm	Good	To be preserved	
108.	Gingko biloba	20cm	Good	To be preserved	
109.	Gingko biloba	20cm	Good	To be preserved	
110.	Quercus rubrum	20cm	Good	To be preserved	
111.	Malus rosaceae	20cm	Good	To be preserved	
112.	Quercus rubrum	25cm	Good	To be preserved	
113.	Quercus rubrum	25cm	Good	To be preserved	
114 <i>A.</i>	Acer platanoides	55cm	Good	To be removed	Co-dominant stems within bark
115.	Quercus rubrum	20cm	Good	To be preserved	<u> </u>
116 <i>A.</i>	Picea glauca	40cm	Fair	To be removed	Suppressed on one side
117. ''a '	Quercus rubrum	20cm	Good	To be preserved	<u> </u>
118A.	Picea glauca	45cm	Good	To be preserved	Suppressed on one side
119.	Quercus rubrum	20cm	Good	To be preserved	
120.	Quercus rubrum	25cm	Good	To be preserved	<u> </u>
121 <i>A.</i>	Sorbus decora	10-25cm	Good	To be removed	Multi-trunk
122 <i>A.</i>	Picea glauca	30cm	Good	To be removed	
123 <i>A</i> .	Juglans nigra	60cm	Good	To be preserved	
124 <i>A</i> .	Juglans nigra	60cm	Good	To be preserved	
125 <i>A.</i>	Juglans nigra	35cm	Good	To be preserved	
126A.	Juglans nigra	55cm	Good	To be preserved	
127 <i>A.</i>	Juglans nigra	35cm	Good	To be preserved	
128.	Prunus sp.	15cm	Fair	To be removed	Sucker from stump
129A.	Acer platanoides	30cm	Fair	To be removed	Suppressed on one side
13 <i>0.</i>	Thuja occidentalis	45cm	Fair	To be removed	
131 <i>A</i> .	Thuja occidentalis	45cm	Fair	To be removed	
132 <i>A.</i>	Thuja occidentalis	45cm	Fair	To be removed	
133.	Acer saccharum	30cm	Fair	To be removed	
34 <i>A.</i>	Prunus virginiana	10-20cm	Fair	To be removed	Clump
135 <i>A.</i>	Juglans nigra	25cm	Good	To be removed	
136.	Gleditsia triacanthos	15cm	Good	To be preserved	1
137.	Cercidiphyllum japonicum		Good	To be preserved	
138A.	Juglans nigra	15cm	Fair 	To be removed	
139 <i>A.</i>	Juglans nigra	25cm	Fair	To be removed	
140A.	Juglans nigra	25cm	Fair	To be removed	
	Acer negundo	45cm	Fair	To be removed	Boundary tree, see note on Li
	1				
141 <i>A.</i> 142 <i>A.</i>	Acer negundo	45cm 40cm	Fair	To be removed	Boundary tree, see note on L1



12 Jul.22.20 Issued for SPA resubmission 3
AWI
11.Jul.13.20 Re—issued for Permit
10.May.25.20 Issued for SPA resubmission 2
9. Mar.20.20 Issued for MOHLTC Working Drawing Review
8. Mar.13.20 Issued for SPA Resubmission
7. Feb.26.20 Issued for Coordination
6. Dec.23.19 Issued for Building Permit
5. Dec.6.19 Issued for 60% Contract Documents
4. Nov.26.19 Issued for Class B Costing
3. Aug.28.19 Issued for 100% DD
CMI
2. Aug.12.19 Issued for SPA
1. Nov.30.18 For coordination
Dec. Modate description
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GPL LTC FACILITY & NCAM 555 COURTHOUSE ROAD TOWN OF COBOURG


Tree Inventory


Mackinnon & Associates a division of 907216 Ontario Inc.

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Landscape and Environmental Planning

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DRAWN BY:	DESIGNED BY		APPROVED BY:	
KLH		CMH	AWH	
PROJECT NO.	SCALE:		DATE:	
2018-36		As Noted	October 26, 2018	
PLOTTED:	SHEET:		•	
July 22, 2020		12		



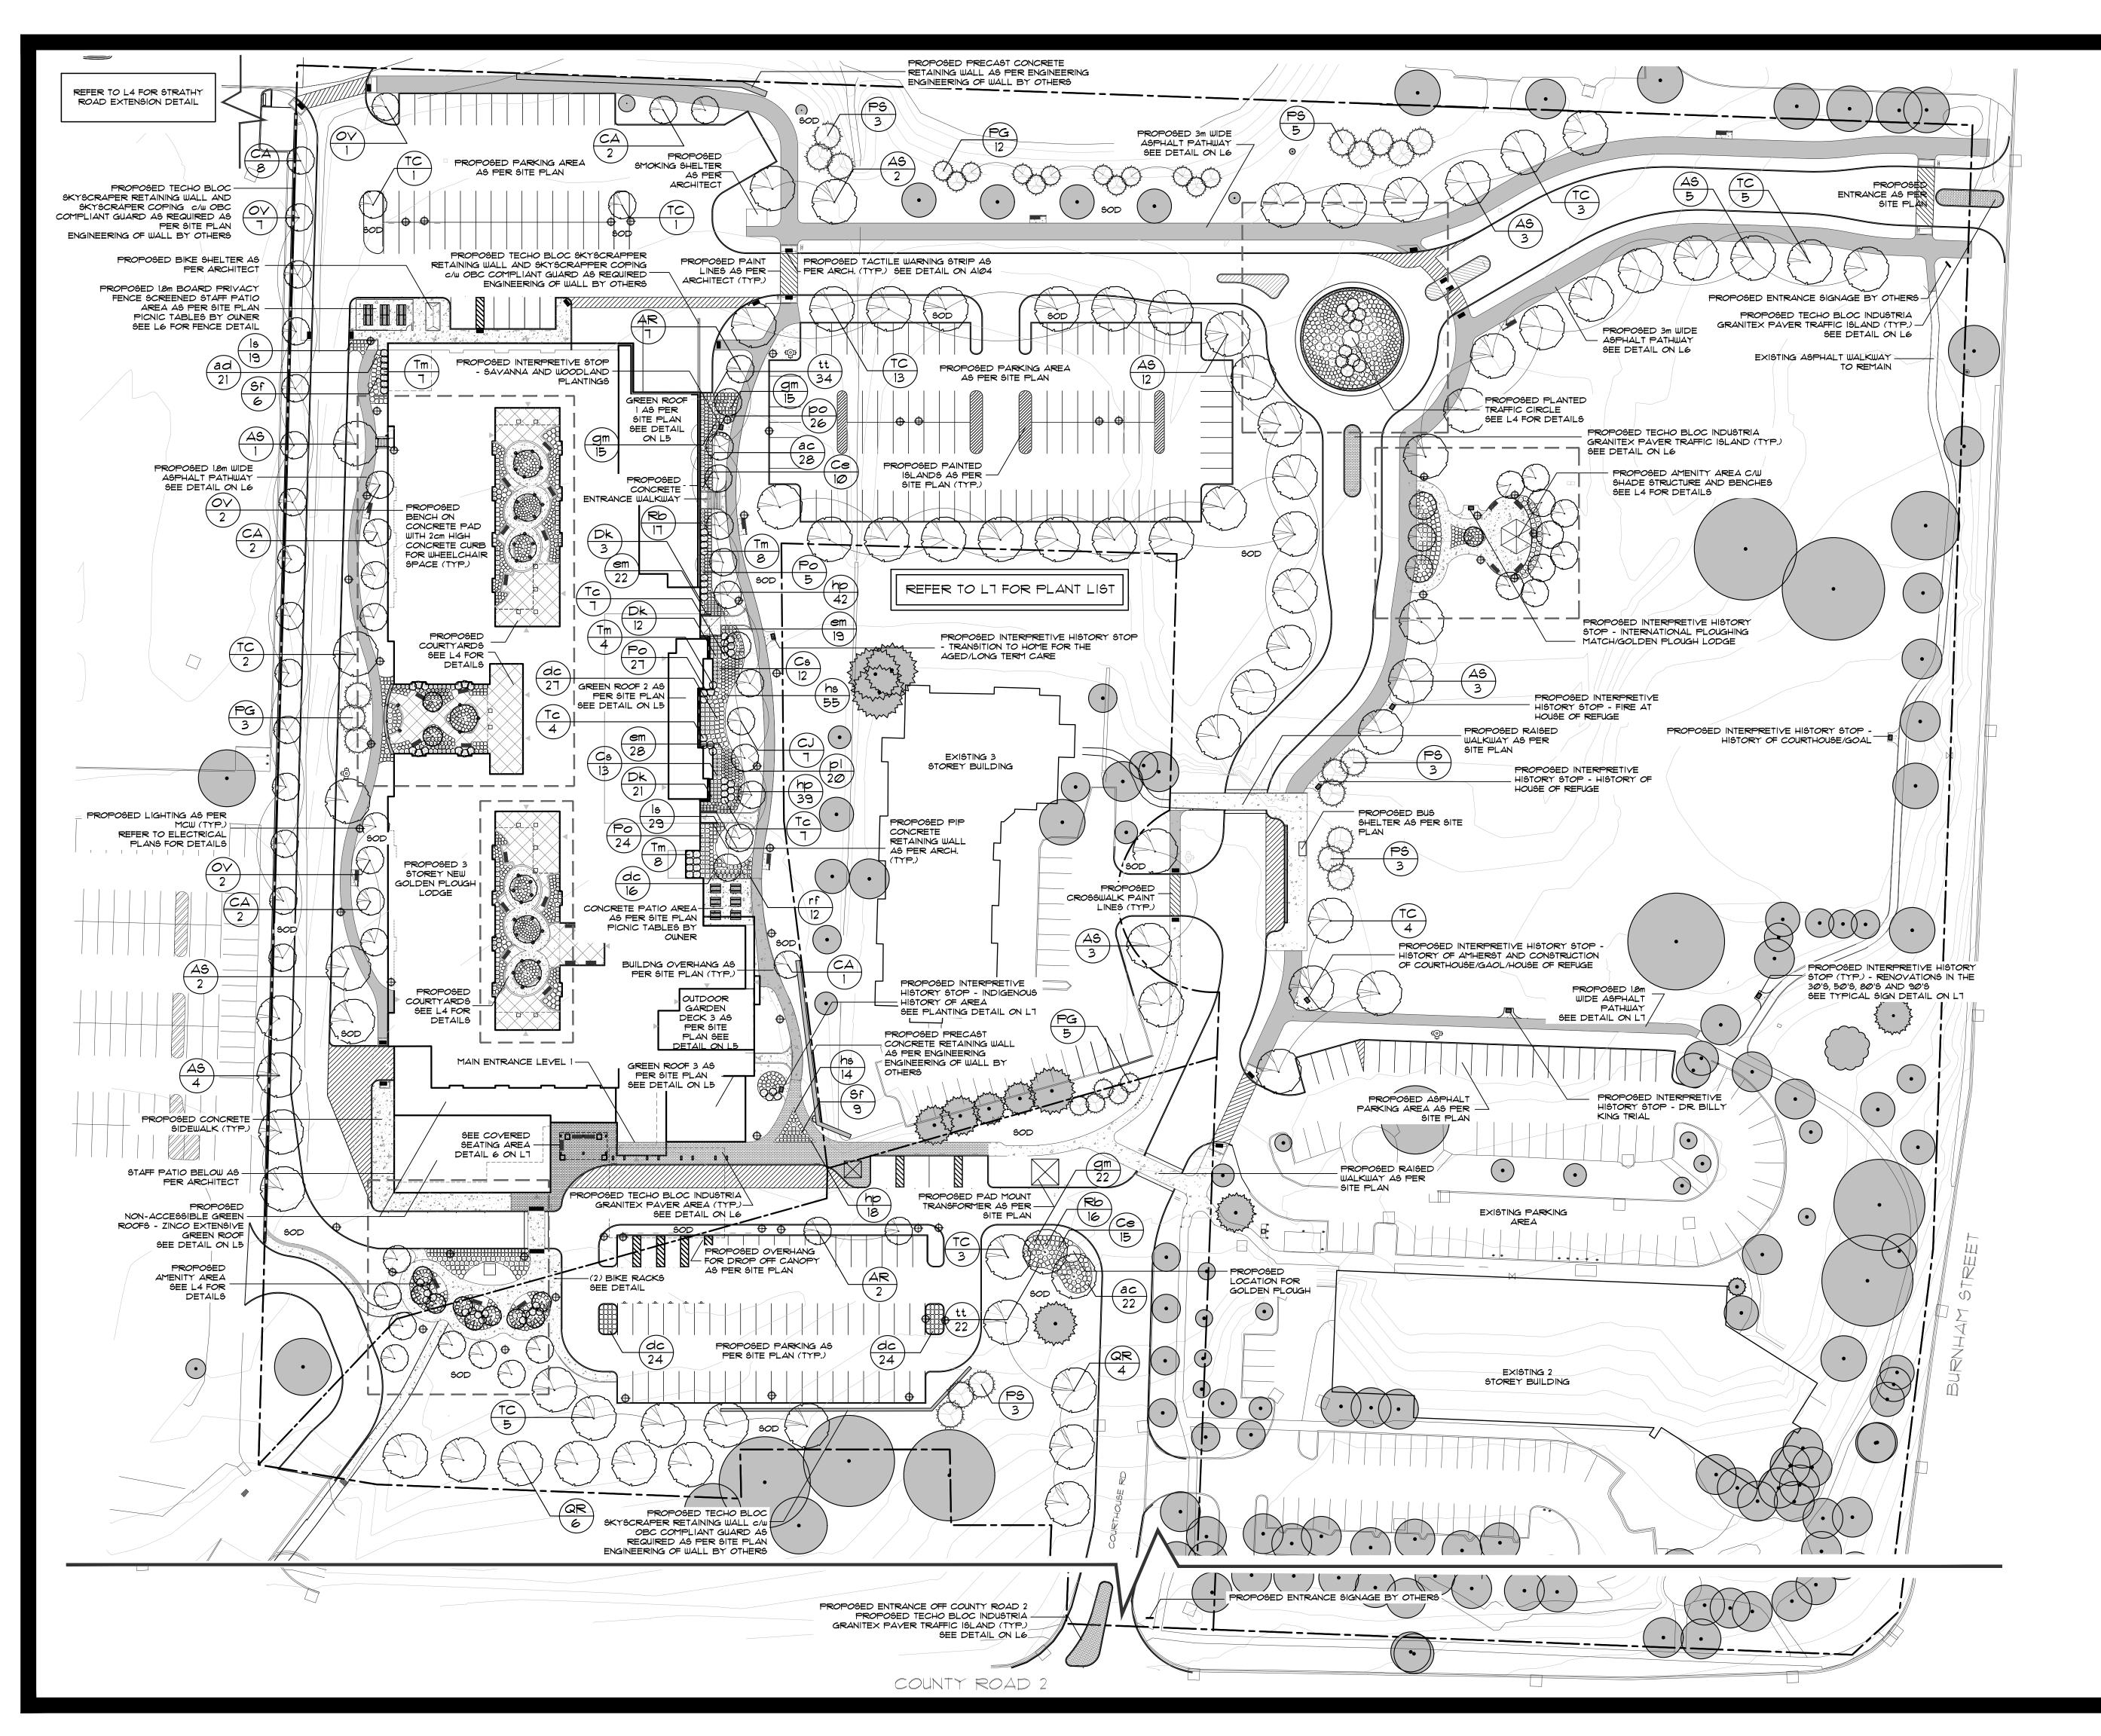
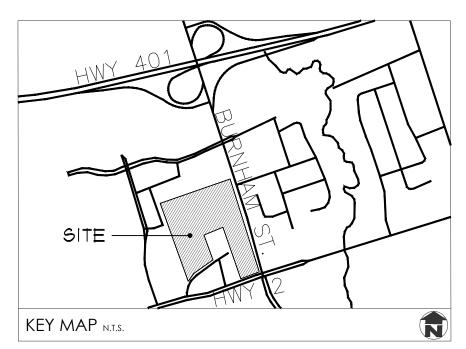
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- 17. ENGINEERING AS PER LEA CONSULTING LTD.





- GPL LTC FACILITY & NCAM 555 COURTHOUSE ROAD TOWN OF COBOURG

Landscape Plan


MacKinnon & Associates


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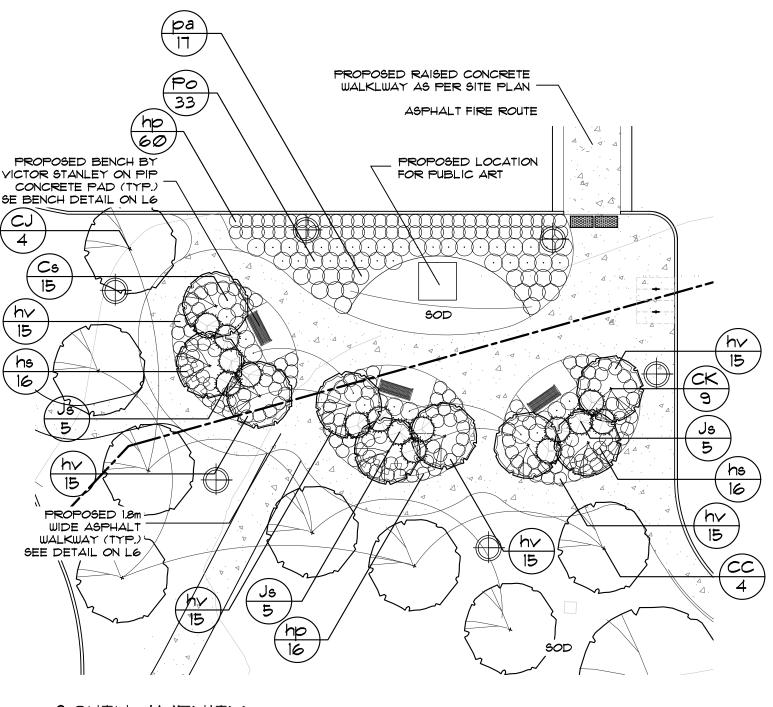
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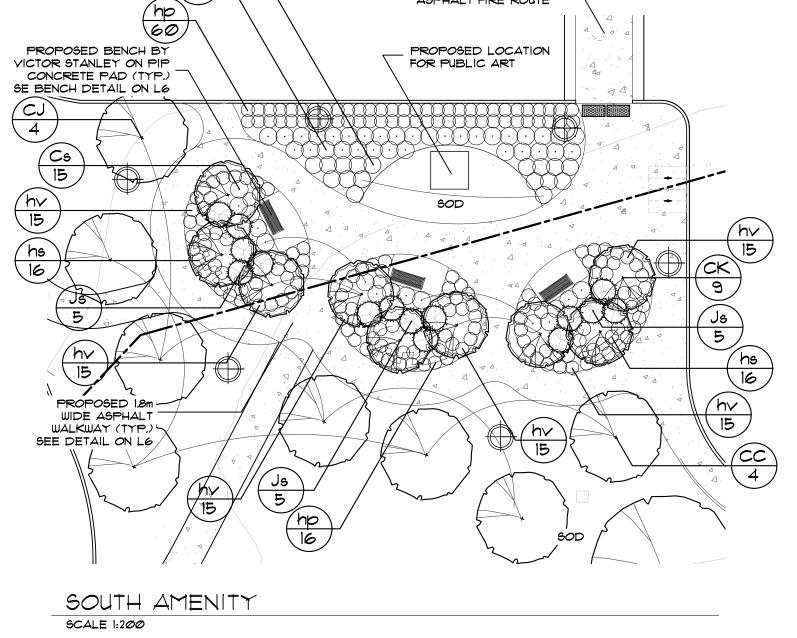
550 Parkside Drive, Unit A-21, Waterloo, Ontario N2L 5V4
Tel. (519) 725-5140 FAX (519) 725-5144


DRAWN BY:	DESIGNED E	3Y:	APPROVED F	3Y:
BH/KLH		CMH/AWH		AWH
PROJECT NO.	SCALE:		DATE:	
2018-36		1:500	July	2018
PLOTTED:	SHEET:		•	
July 22, 2020		L3		





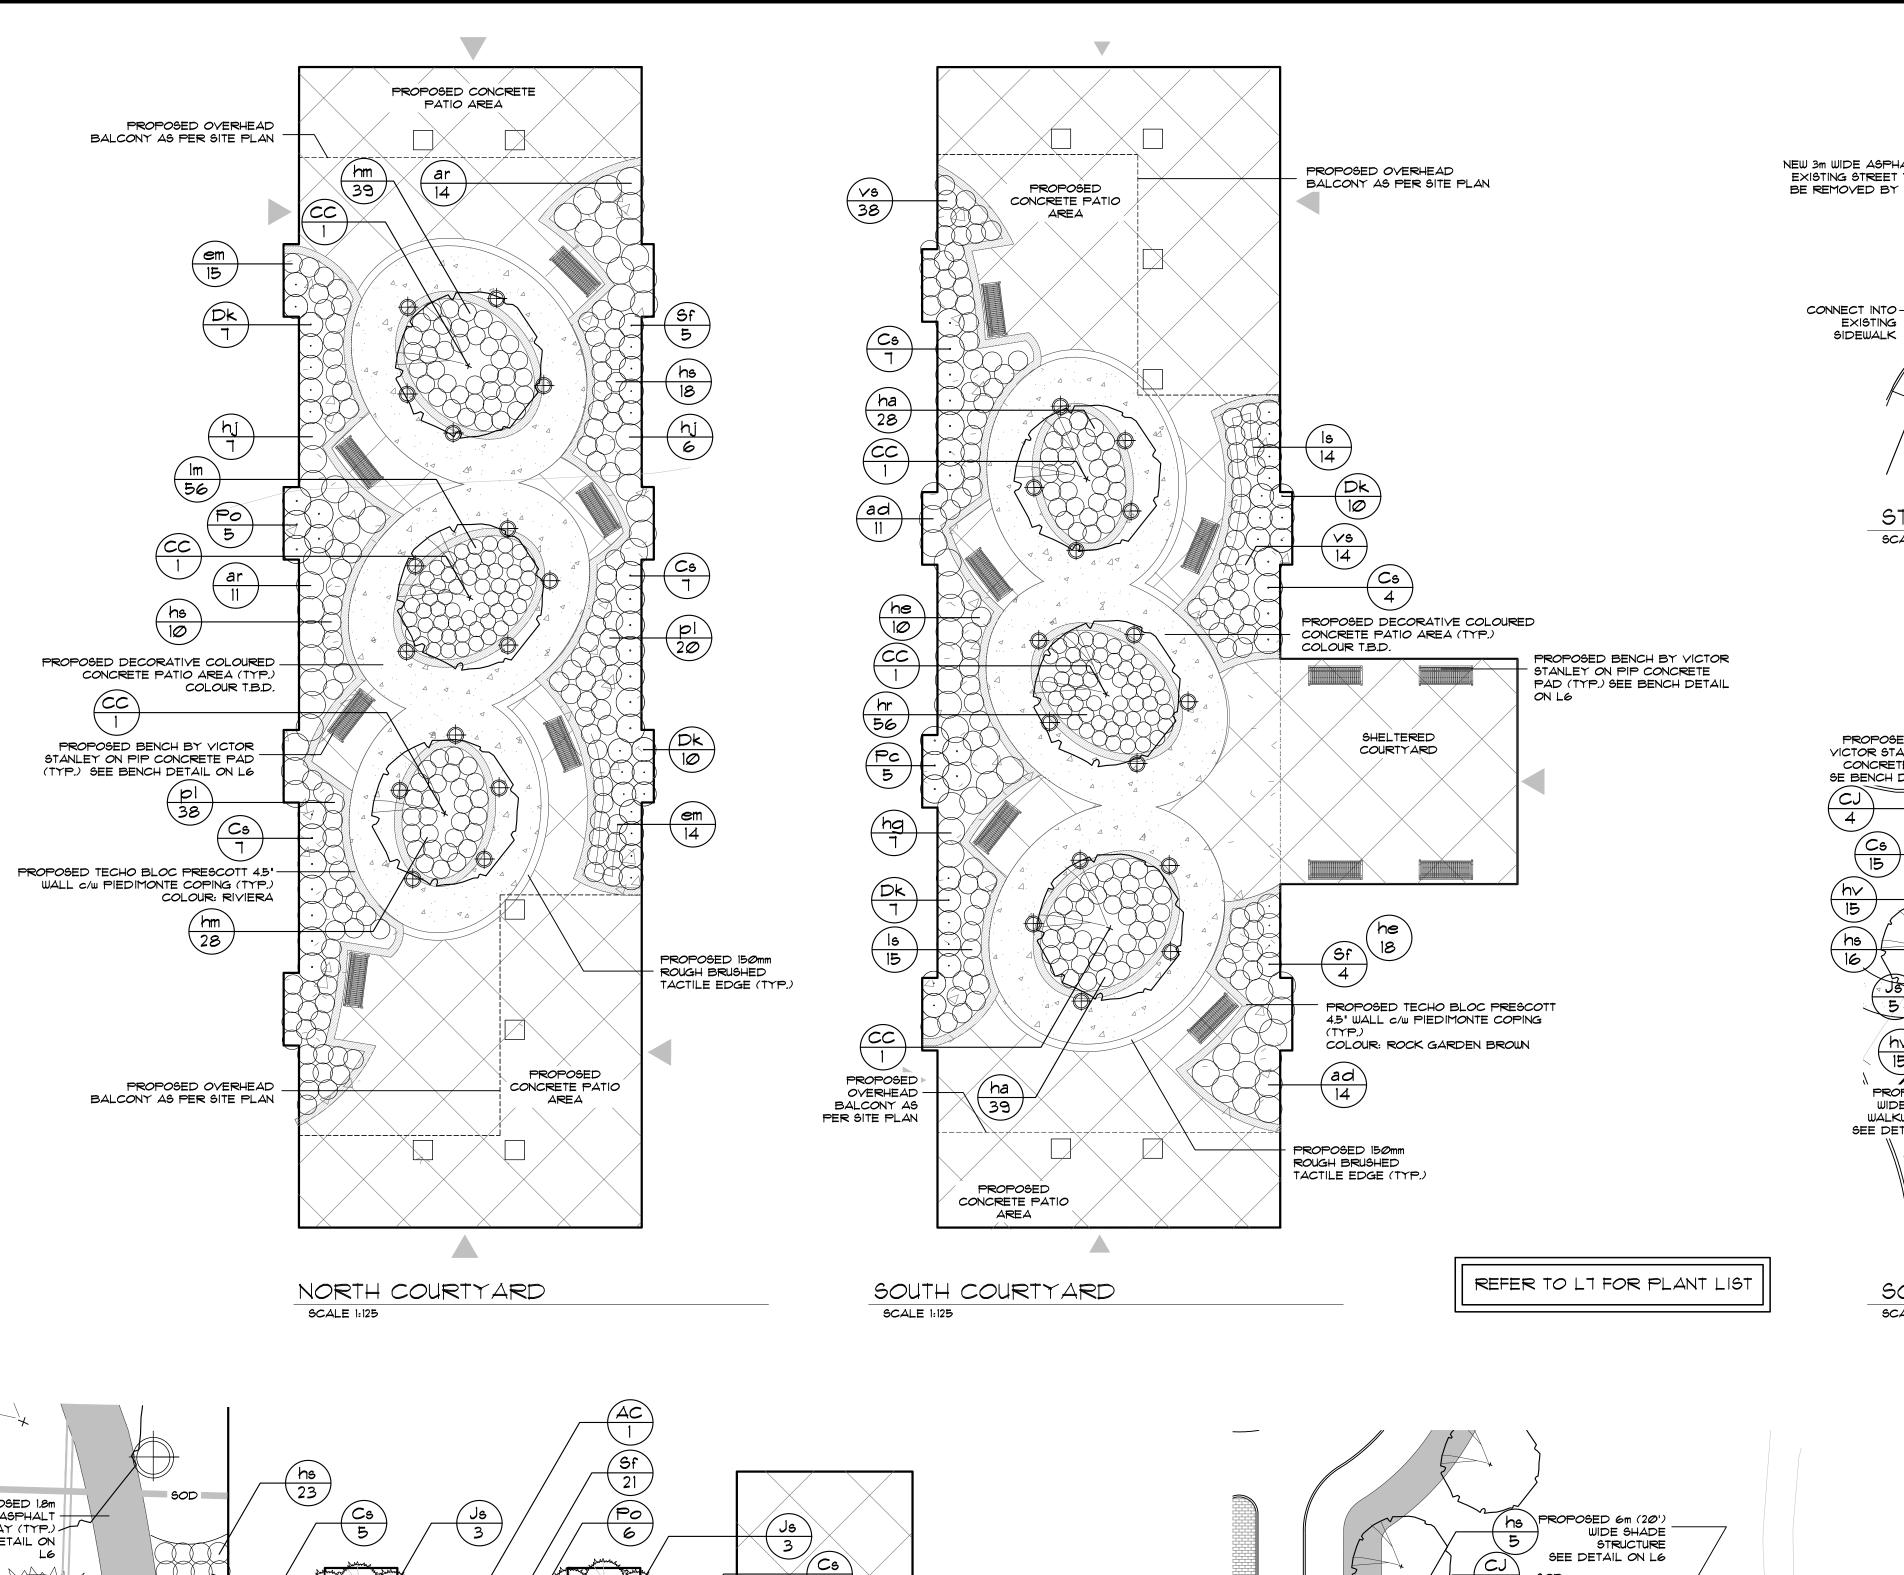

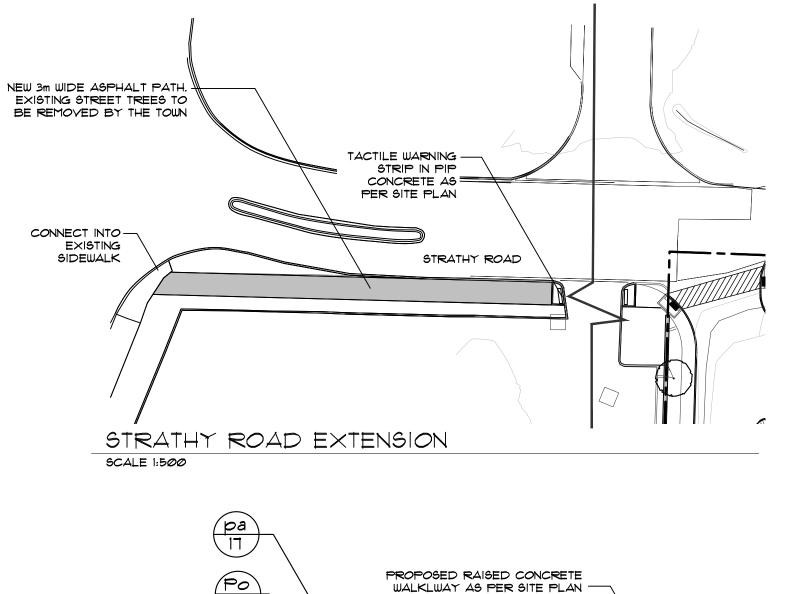

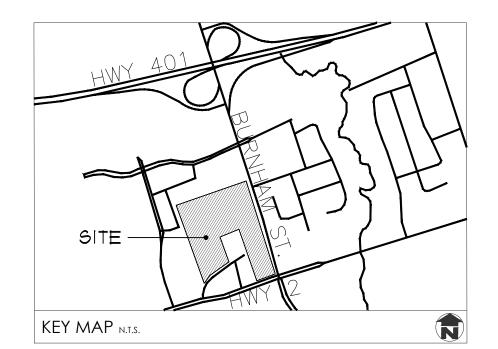



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GPL LTC FACILITY & NCAM 555 COURTHOUSE ROAD TOWN OF COBOURG


Landscape Englargments

MacKinnon & Associates


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DRAWN BY:	DESIGNED BY	:	APPROVED BY:
BH/KLH		CMH/AWH	AWH
PROJECT NO.	SCALE:		DATE:
2018-36		1:500	July 2018
PLOTTED:	SHEET:		
July 22, 2020		L	4

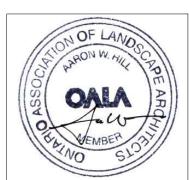

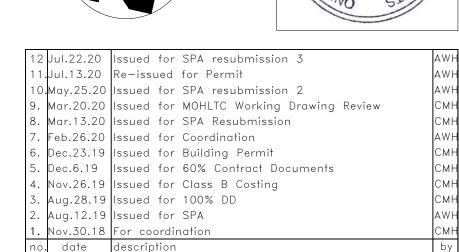SCALE 1:125

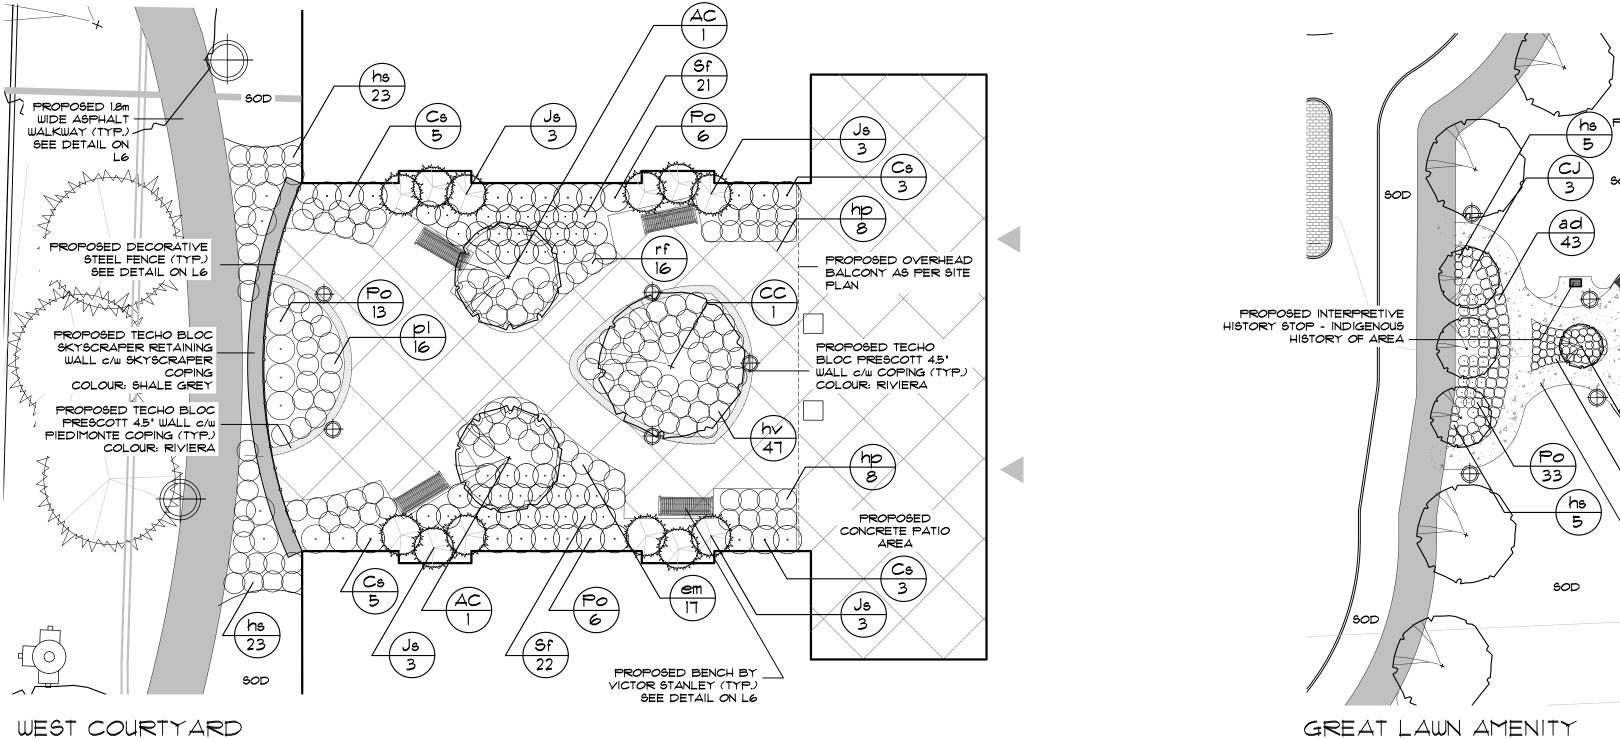

PROPOSED CONCRETE

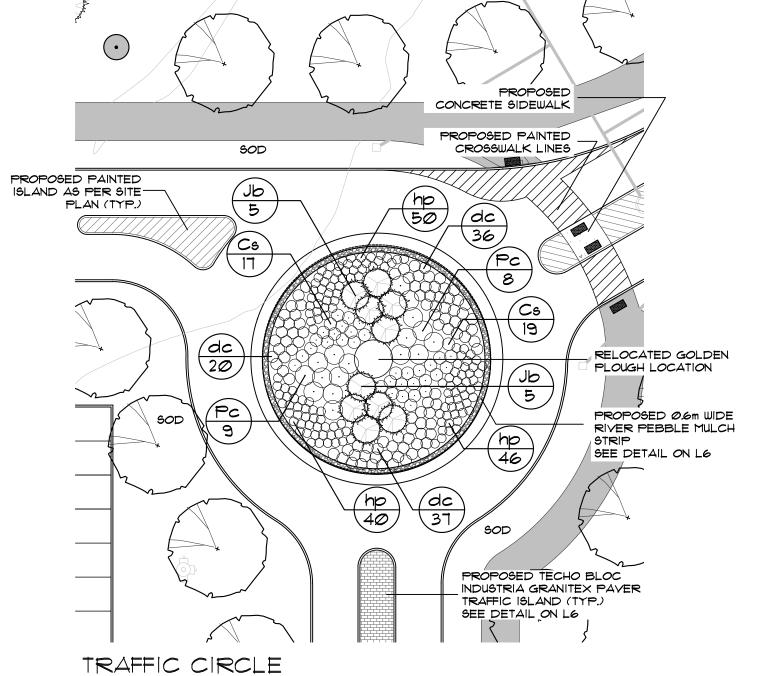
PROPOSED BENCH BY VICTOR STANLEY (TYP.)

SEE DETAIL ON L6

- PATIO AREA

PROPOSED 1.8m WIDE

CONCRETE PATHWAY

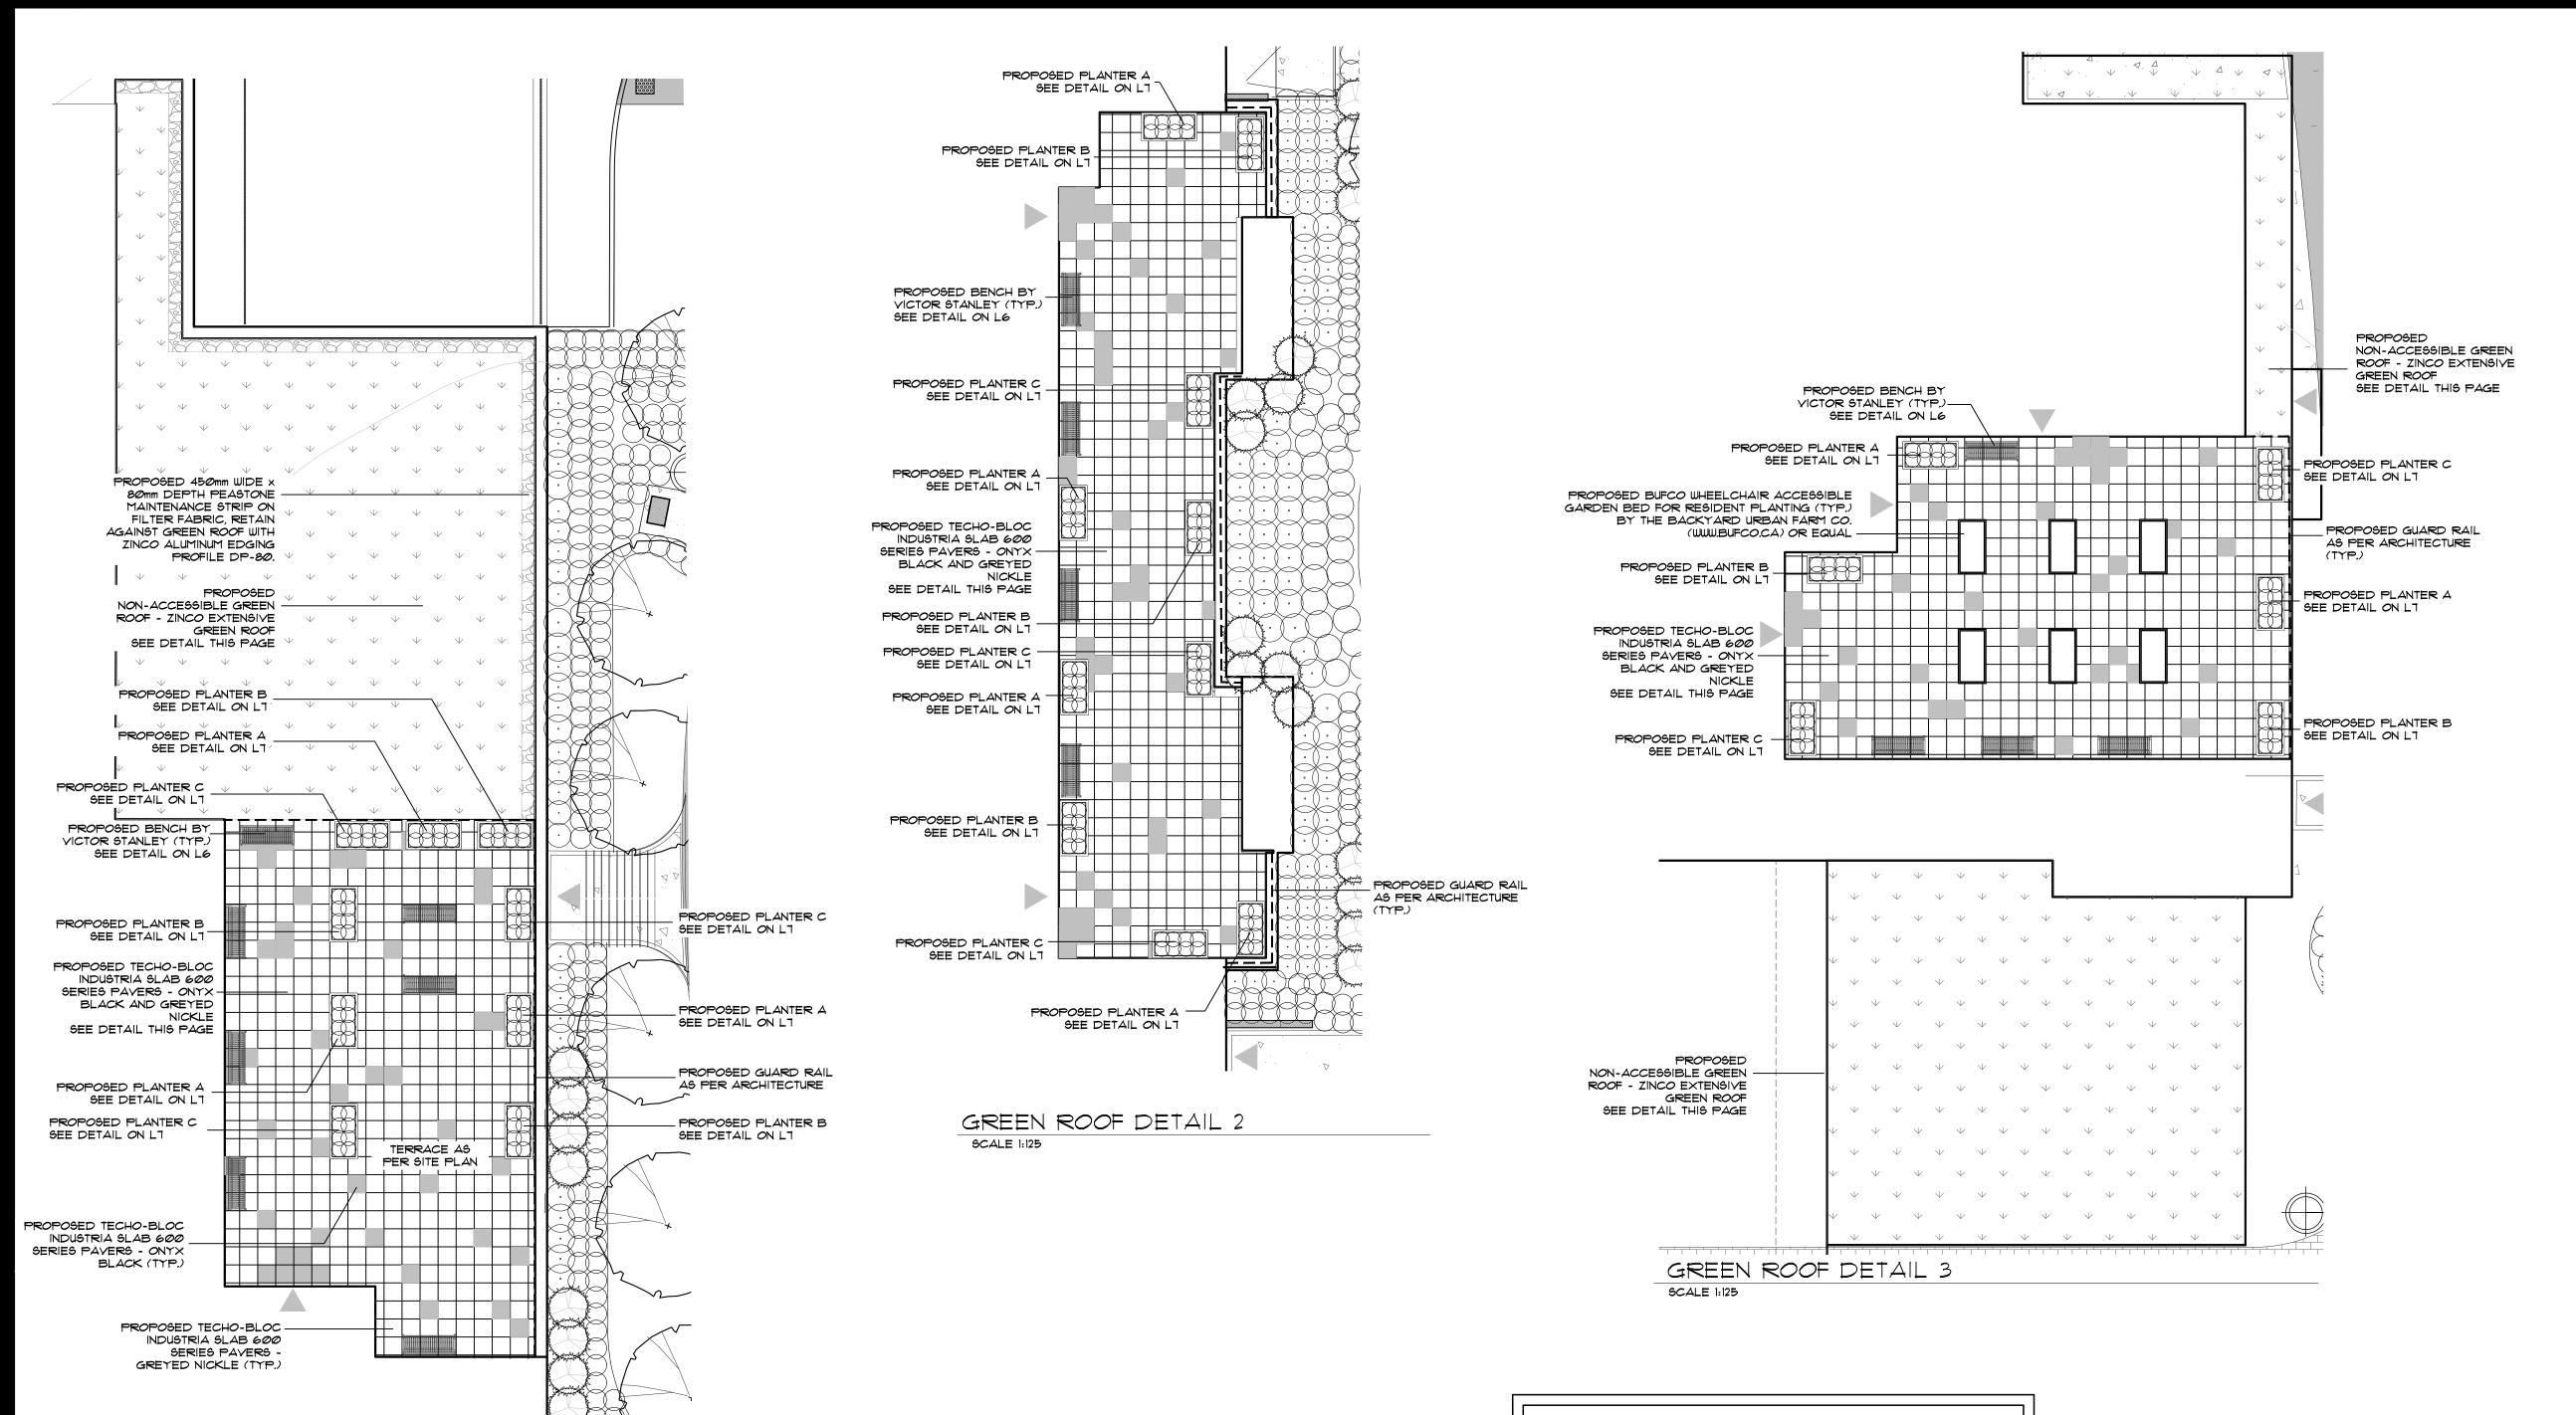


TO BE INSTALLED AS PER MANUFACTURER'S SPECIFICATIONS PAVERS AND PEDESTALS BY TECHO-BLOC (OR APPROVED EQUAL) T: 1-877-832-4625

WWW.TECHO-BLOC.COM TECHO-BLOC PAVERS

MODEL: INDUSTRIA SLAB 600 SERIES COLOURS: ONYX BLACK AND GREYED NICKEL

TECHO-BLOC PEDESTAL MODEL: BC-SERIE PEDESTAL SYSTEM BY BUZON (SUPPLIED BY TECHO-BLOC)

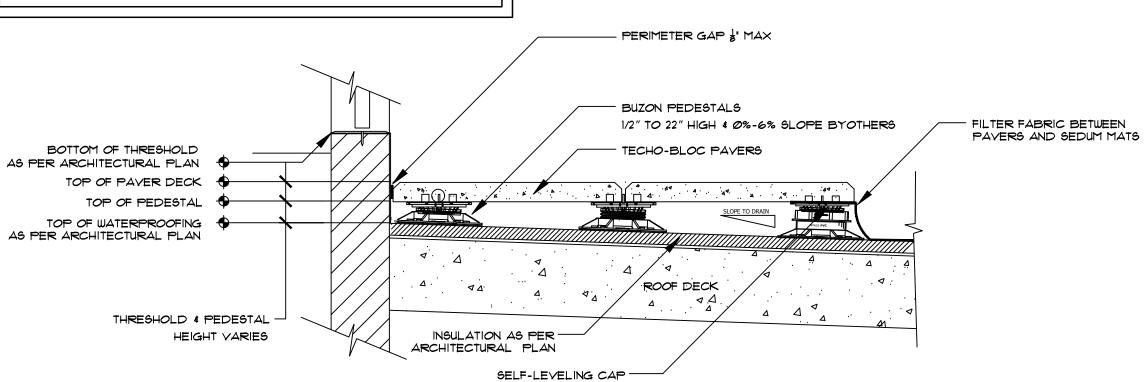


ROOF TOP UNIT PAVER DETAIL



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- 2 Jul.22.20 Issued for SPA resubmission 3 Jul.13.20 Re-issued for Permit 0.May.25.20 Issued for SPA resubmission 2 Mar.20.20 Issued for MOHLTC Working Drawing Review Mar.13.20 Issued for SPA Resubmission Feb.26.20 Issued for Coordination Dec.23.19 Issued for Building Permit Dec.6.19 Issued for 60% Contract Documents Nov.26.19 Issued for Class B Costing Aug.28.19 Issued for 100% DD Aug.12.19 Issued for SPA Nov.30.18 For coordination
- GPL LTC FACILITY & NCAM 555 COURTHOUSE ROAD TOWN OF COBOURG

Green Roof Englargments & Details


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. date description
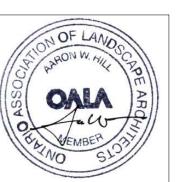
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550 Parkside Drive, Unit A-21, Waterloo, Ontario N2L 5V4 Tel. (519) 725-5140 FAX (519) 725-5144

DRAWN BY:	DESIGNED B	BY:	APPROVED BY:	
BH/KLH		CMH/AWH	AWH	
PROJECT NO.	SCALE:		DATE:	
2018-36		1:500	July 2018	
PLOTTED:	SHEET:		•	
July 22, 2020		L5		



<u>NOTES</u>

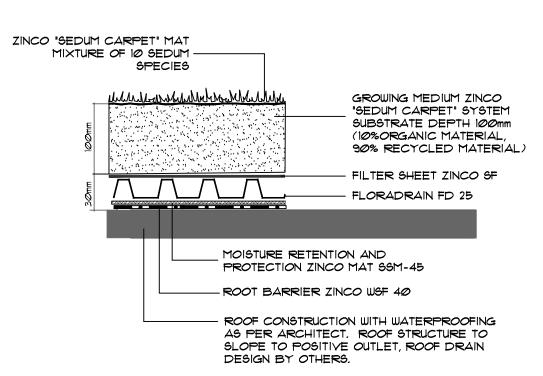EXTENSIVE GREEN ROOF COMPONENTS BY ZINCO CANADA INC. (905-690-1661) (greenroof@zinco.ca) OR APPROVED EQUIVALENT. STRUCTURAL ENGINEER TO CONFIRM LOAD BEARING CAPACITY OF STRUCTURE BEFORE PLANTING.


ENSURE ALL ROOF PLANTING AREAS HAVE A POSITIVE DRAINAGE OUTLET (DESIGN AND LAYOUT BY OTHERS).


GREEN ROOF ELEMENTS ARE PROVIDED FOR REFERENCE PURPOSES ONLY -MANUFACTURER TO PROVIDE FINAL BUILD UP SHOP DRAWING FOR REVIEW.

PRELIMINARY ZINCO EXTENSIVE GREEN ROOF DETAIL

GREEN ROOF DETAIL

SCALE 1:125

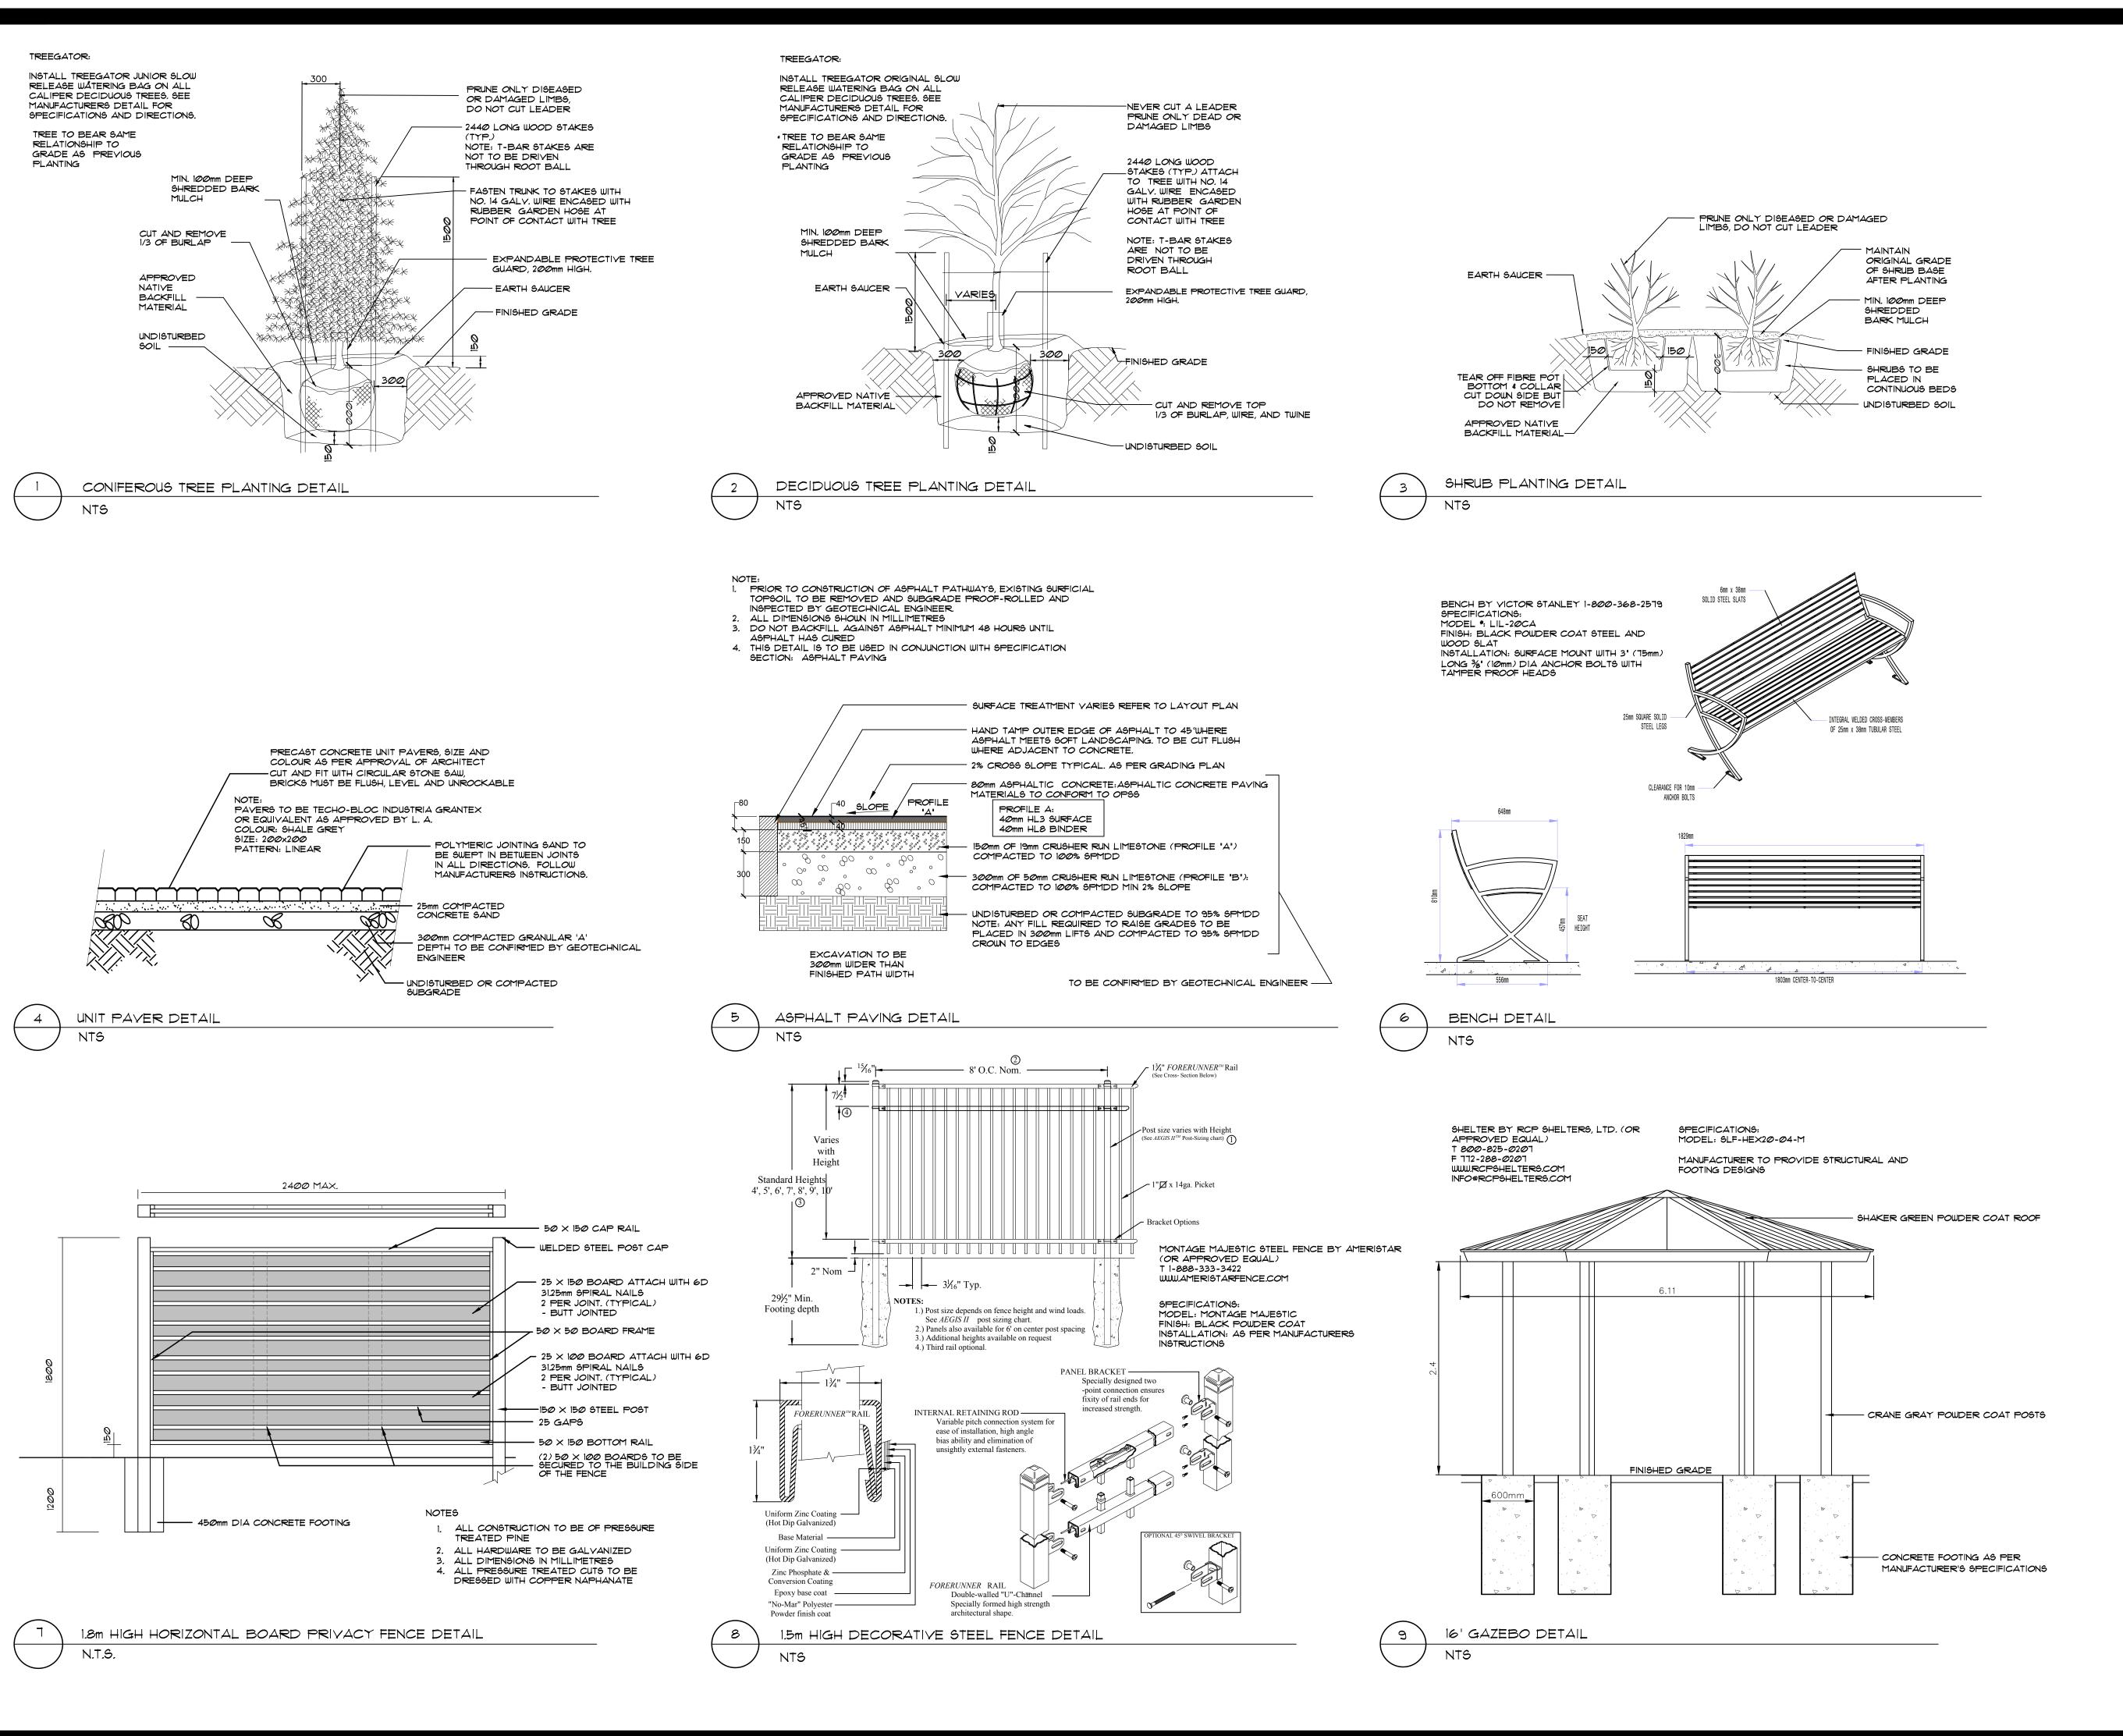

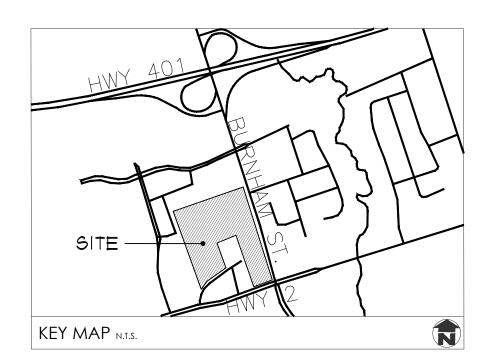

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LANDSCAPE ARCHITECT.

- ARCHITECT PRIOR TO INSTALLATION.

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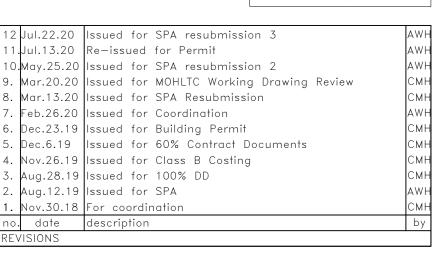
QUANTITIES NOTED WITHIN THE PLAN SUPERCEDE THOSE IN THE

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GPL LTC FACILITY & NCAM 555 COURTHOUSE ROAD TOWN OF COBOURG


Landscape Details


MacKinnon & Associates


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BH/KLH		CMH/AWH	AWH	
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2018-36		1:500	July 2018	
PLOTTED:	SHEET:			
July 22, 2020		L6		






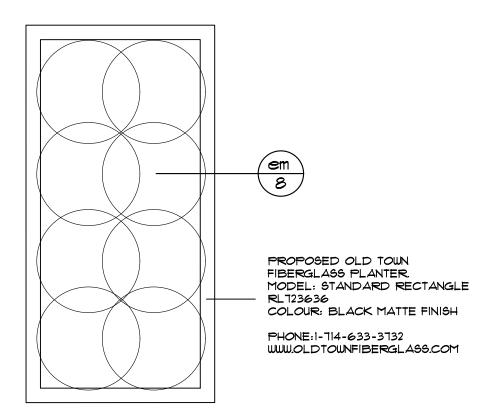


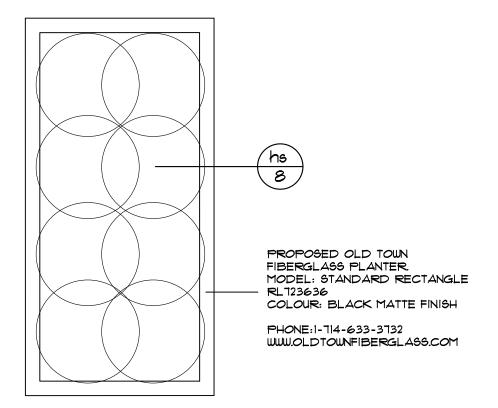

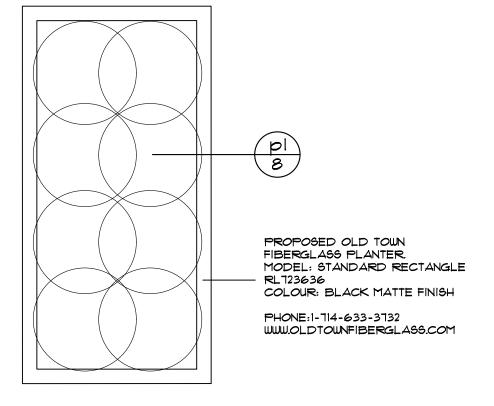PLANTER B PLANTING DETAIL

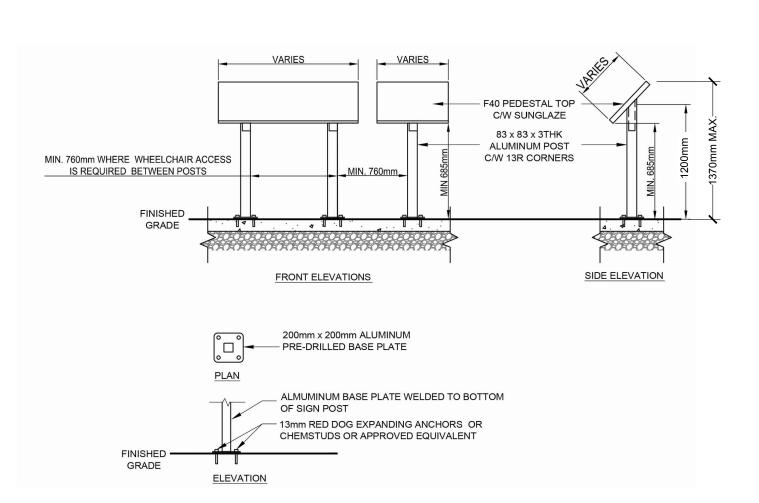


INTERPRETIVE SIGN DETAIL

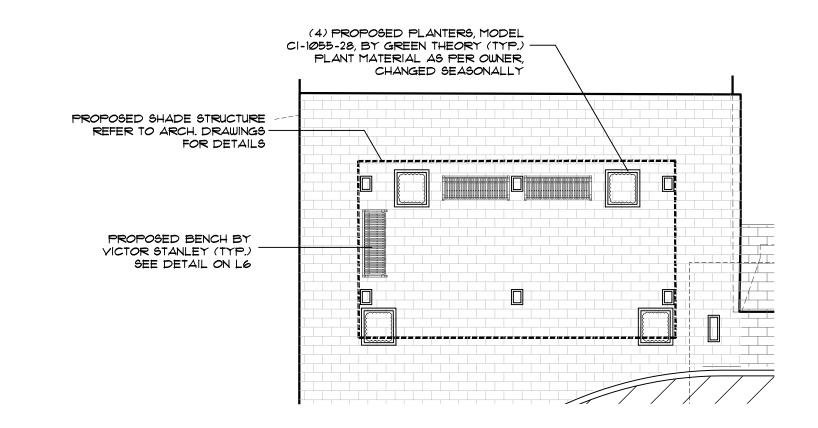

COVERED SEATING AREA DETAIL 1:100

INDIGENOUS PLANTING AREA DETAIL

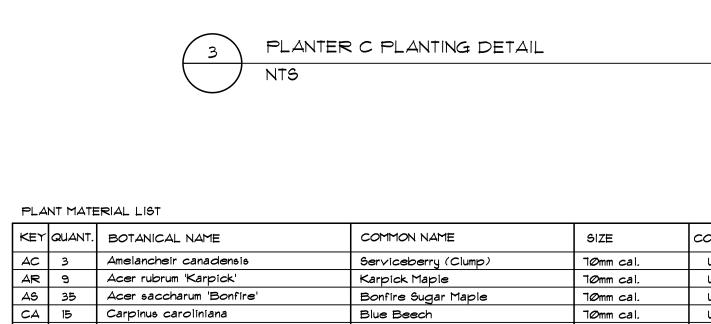

KEY	QUANT.	BOTANICAL NAME	COMMON NAME	SIZE	COND.
AC	3	Amelancheir canadensis Serviceberry (Clump)		7∅mm cal.	W.B.
AR	9	Acer rubrum 'Karpick'	Karpick Maple	7∅mm cal.	W.B.
AS	35	Acer saccharum 'Bonfire'	Bonfire Sugar Maple	7∅mm cal.	W.B.
CA	15	Carpinus caroliniana	Blue Beech	7∅mm cal.	W.B.
CC	16	Cercis canadensis	Redbud (Clump)	7∅mm cal.	W.B.
CJ	18	Cercidiphyllum japonicum Red Fox	Red Fox Katsura	7∅mm cal.	W.B.
CK	9	Cornus kousa Samaritan	Samaritan Dogwood (Treeform)	7∅mm cal.	W.B.
0	12	Ostrya virginiana	Ironwood	7∅mm cal.	W.B.
PG	20	Picea glauca	White Spruce	250cm ht.	W.B.
PS	П	Pinus strobus	White White Pine	250cm ht.	W.B.
QR	10	Quercus rubra	Red Oak	7∅mm cal.	W.B.
TC	37	Tilia cordata Greenspire	Greenspire Linden	7∅mm cal.	W.B.
			·		
Ce	25	Ceanothus americanus	New Jersey Tea	60cm, 3 gal.	Pot
Cs	155	Cornus sanguinea 'Winter Beauty'	Winter Beauty Dogwood	60cm, 3 gal.	Pot
Dk	7Ø	Diervilla x Kodiak Orange	Kodiak Orange Honeysuckle	60cm, 3 gal.	Pot
Jb	10	Juniperus sabina 'Blue Danube'	Blue Danube Juniper	60cm, 3 gal.	Pot
Js	27	Juniperus sabina	Savin Juniper	60cm, 3 gal.	Pot
Po	154	Physocarpus opulifolius 'Dart's Gold'	Dart Gold Ninebark	60cm, 3 gal.	Pot
Pc	22	Physocarpus opulifolis 'Centre Glow'	Centre Glow Ninebark	60cm, 3 gal.	Pot
8	33	Rosa blanda	Smooth Rose	60cm, 3 gal.	Pot
Sf	67	Spiraea japonica 'Froebelii'	Froebelii Spirea	60cm, 3 gal.	Pot
Tc	18	Taxus cuspidata Emerald Spreader	Emerald Spreader Yew	150cm ht.	W.B.
Tm	27	Taxus x media 'Densiformis'	Dense Yew	150cm ht.	W.B.
Τo	38	Thuja occidentalis 'Little Giant'	Little Giant Cedar	60cm, 3 gal.	Pot
ac	50	Aquilegia canadensis	Wild Columbine	1 gal.	Pot
ad	89	Astilbe x 'Delft Lace'	Delft Lace Astilbe	1 gal.	Pot
ar	25	Astilbe japonica 'Red Sentinel'	Red Sentinel Astilbe	1 gal.	Pot
dc	184	Deschampsia cespitosa	Tufted Hair Grass	1 gal.	Pot
em	172	Echinacea purpurea 'Merlot'	Meriot Coneflower	1 gal.	Pot
gm_	52	Geranium maculatum	Wild Geranium	1 gal.	Pot
ha	67	Hosta 'Aphrodite'	Aphrodite Hosta	1 gal.	Pot
he	19	Hemerocallis 'Joan Senoir'	Joan Senoir Daylily	1 gal.	Pot
hg	5	Hosta 'Stained Glass'	Stained Glassm Hosta	1 gal.	Pot
hj	11	Hosta 'June'	June Hosta	i gal.	Pot
hm	67	Hakonechioa macra 'Aureola'	Variegated Japanese Forest Grass	1 gal.	Pot
ho	13	Hierochloe odorata	Sweet Grass	1 gal.	Pot
hp	327	Hemerocallis 'Purple d'Oro'	Purple d'Oro Daylily	1 gal.	Pot
hr	56	Hemerocallis 'Rosy Returns'	Rosy Returns Daylily	1 gal.	Pot
hs	233	Hemerocallis 'Stella d'Oro'	Stella d'Oro Daylily	1 gal.	Pot
hv	214	Hosta 'Yulcan'	Vulcan Hosta	1 gal.	Pot
lm	56	Leucanthemum x superbum 'Becky'	Becky Daisy	1 gal.	Pot
ls	120	Liriope spicata 'Silver Dragon'	Silver Dragon Lily Turf	i gal.	Pot
ра	15	Pennisetum alopecuroides 'Moudry'	Moudry Fountain Grass	1 gal.	Pot
рΙ	142	Perovskia x 'Little Spire'	Little Spire Russian Sage	1 gal.	Pot
ро	26	Poa compressa	Canada Bluegrass	1 gal.	Pot
rf	28	Rudbeckia fulgida 'Goldstrum'	Black Eyed Susan	1 gal.	Pot
50	13	Salvia officinalis	Perennial Sage	1 gal.	Pot
	5.6	Lirione enicata 'Gilver Dragon'	Silver Dragon Lilu Turs	1 0 0 1	T

Silver Dragon Lily Turf


Red Fox Veronica

Pot

1 gal.

56 Liriope spicata 'Silver Dragon'

vs 58 Veronica spicata 'Red Fox'

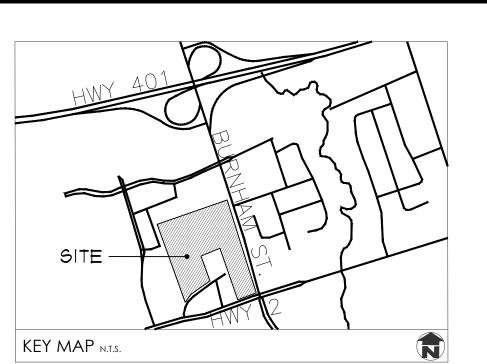

GENERAL NOTES

- 1. ALL WORKMANSHIP WILL BE TO THE STANDARDS OF LANDSCAPE
- 2. ALL PLANT MATERIAL TO BE NO.1 GRADE NURSERY GROWN IN ACCORDANCE WITH THE CANADIAN STANDARDS FOR NURSERY STOCK, 6TH EDITION, 1998, BY THE CANADIAN NURSERY TRADES ASSOCIATION.
- 3. BACKFILL WILL CONSIST OF SOIL NATIVE TO THE SITE OR GENERAL SOIL TYPE/CLASS NATIVE TO THE SITE. TOPSOIL TO BE TESTED FOR NUTRIENT VALUE, AND AMENDED FOR OPTIMAL GROWTH AS PER THE RECOMMENDATIONS OF THE SOIL TEST.
- 4. CONTRACTOR SHALL MAINTAIN ALL LANDSCAPE AREAS UNTIL OWNER'S ACCEPTANCE OF PROJECT.
- 5. CONTRACTOR TO LOCATE ALL UNDERGROUND UTILITIES. 6. PLANTING MAY BE ADJUSTED TO SUIT LOCATIONS OF SITE UTILITY STRUCTURES/SERVICES.
- 7. ALL MATERIALS MUST BE APPROVED BY LANDSCAPE ARCHITECT PRIOR TO INSTALLATION.
- 8. SPREAD MULCH TO A MINIMUM OF 100mm COMPACTED DEPTH ON ALL TREE PITS AND PLANTING BEDS.
- 9. CHECK AND VERIFY ALL DIMENSIONS AND QUANTITIES PRIOR TO COMMENCEMENT OF WORK. ANY DISCREPANCIES ARE TO BE REPORTED IN WRITING TO THE LANDSCAPE ARCHITECT. QUANTITIES NOTED WITHIN THE PLAN SUPERCEDE THOSE IN THE PLANT LIST. ANY SUBSTITUTIONS SHALL BE APPROVED BY THE LANDSCAPE ARCHITECT.
- 10. SOD AS MARKED WITH NURSERY SOD ON A MINIMUM OF 100mm OF CLEAN TOPSOIL. FINE GRADE AND SOD ALL BOULEVARD AREAS TO MUNICIPAL SPECIFICATIONS AND REPAIR DAMAGE TO ADJACENT PROPERTIES, AS REQUIRED.
- II. FINAL INSPECTION AND ACCEPTANCE OF PLANTING WORK SHALL COINCIDE WITH THE FINAL INSPECTION AND ACCEPTANCE OF ALL WORK INCLUDED IN THE CONTRACT.
- 12. ALL SEEDED SLOPES 3:1 AND GREATER TO RECEIVE EROSION CONTROL MATTING (COIR MAT, OR OTHER WILDLIFE FRIENDLY ALTERNATIVE). PIN 60D ON ALL SLOPES OF 3:1 OR GREATER.
- 13. SUBMIT A WRITTEN GUARANTEE TO THE EFFECT THAT ALL PLANTS ACCEPTED DURING THE PERIOD OF JANUARY 1st TO JULY 15th SHALL BE GUARANTEED UNTIL JULY 15th THE FOLLOWING YEAR PLANTS ACCEPTED DURING THE PERIOD OF JULY 15th TO DECEMBER 31st SHALL BE GUARANTEED FOR ONE YEAR FROM THE DATE OF ACCEPTANCE. THE GUARANTEE PERIODS LISTED ABOVE SHALL APPLY TO ALL "NURSERY GROWN" PLANTS.
- 14. AT THE TIME OF FINAL INSPECTION ALL PLANTS SHALL BE IN A HEALTHY, VIGOUROUS GROWING CONDITION, PLANTED IN FULL ACCORDANCE WITH DRAWINGS AND CONDITIONS.
- 15. SITE PLAN INFORMATION AS PER SALTER PILON ARCHITECTS
- 16. TOPOGRAPHIC AND EXISTING CONDITIONS INFORMATION AS PER LEA CONSULTING LTD., DATED SEPTEMBER 10, 2018.
- 17. ENGINEERING AS PER LEA CONSULTING LTD.





11.	Jul.13.20	Re—issued for Permit	AWH
10.	May.25.20	Issued for SPA resubmission 2	AWH
9.	Mar.20.20	Issued for MOHLTC Working Drawing Review	СМН
8.	Mar.13.20	Issued for SPA Resubmission	СМН
7.	Feb.26.20	Issued for Coordination	AWH
6.	Dec.23.19	Issued for Building Permit	СМН
5.	Dec.6.19	Issued for 60% Contract Documents	СМН
4.	Nov.26.19	Issued for Class B Costing	СМН
3.	Aug.28.19	Issued for 100% DD	СМН
2.	Aug.12.19	Issued for SPA	AWH
1.	Nov.30.18	For coordination	СМН
no.	date	description	by
DEV	/ICIONIC		•

GPL LTC FACILITY & NCAM 555 COURTHOUSE ROAD TOWN OF COBOURG

Landscape Details



oviding Solutions in Urban, 🏻 🌞 andscape and Environmental Planning

550 Parkside Drive, Unit A-21, Waterloo, Ontario N2L 5V4 Tel. (519) 725-5140 FAX (519) 725-5144

DRAWN BY:	DESIGNED BY	Υ:	APPROVED BY:	
BH/KLH		CMH/AWH	AWH	
PROJECT NO.	SCALE:		DATE:	
2018-36		1:500	July 2018	
PLOTTED:	SHEET:			
July 13,2020		L7		