





TREE PROTECTION NOTES

- a. ALL EXISTING TREES WHICH ARE TO REMAIN SHALL BE FULLY PROTECTED WITH HOARDING ERECTED BEYOND THE DRIP LINE TO THE SATISFACTION OF THE RECREATION & PARKS DEPARTMENT PRIOR TO THE ISSUANCE OF THE BUILDING PERMIT. GROUPS OF TREES AND OTHER EXISTING VEGETATION TO BE PROTECTED WITH HOARDING AROUND THE ENTIRE AREA. AREAS WITHIN THE PROTECTIVE FENCING SHALL REMAIN UNDISTURBED AND SHALL NOT BE USED FOR THE STORAGE OF
- b. NO RIGGING CABLES SHALL BE WRAPPED AROUND OR INSTALLED IN THE TREES AND SURPLUS SOIL, EQUIPMENT, DEBRIS OR MATERIALS SHALL NOT BE PLACED OVER THE ROOT SYSTEMS OF THE TREES WITHIN THE PROTECTIVE FENCING. NO CONTAMINANTS WILL BE DUMPED OR FLUSHED WHERE FEEDER ROOTS OF TREES EXIST.
- c. THE DEVELOPER OR AGENTS SHALL TAKE EVERY PRECAUTION NECESSARY TO PREVENT DAMAGE TO THE VEGETATION TO
- d. WHERE LIMBS OF PORTIONS OF TREES ARE REMOVED TO ACCOMMODATE CONSTRUCTION, THEY WILL BE REMOVED IN ACCORDANCE WITH ACCEPTED ARBORICULTURAL PRACTICE.
- e. WHERE ROOT SYSTEMS OF PROTECTED TREES ADJACENT TO CONSTRUCTION ARE EXPOSE OR DAMAGED THEY SHALL BE NEATLY TRIMMED AND THE AREA BACKFILLED WITH APPROPRIATE MATERIAL TO PREVENT DESICCATION.
- f. WHERE NECESSARY, VEGETATION WILL BE GIVEN AN OVERALL PRUNING TO RESTORE THE BALANCE BETWEEN ROOTS AND
- TREES THAT HAVE DIES OR HAVE BEEN DAMAGED BEYOND REPAIR SHALL BE REMOVED AND REPLACED AT THE OWNERS EXPENSE WITH TREES OF A SIZE AND SPECIES APPROVED BY THE RECREATION & PARKS DEPARTMENT.
- h. IF GRADE AROUND TREES TO BE PROTECTED AREA TO CHANGE, THE OWNER SHALL BE REQUIRED TO TAKE PRECAUTIONS SUCH AS DRY WELLING, RETAINING WALLS, AND ROOT FEEDING TO THE SATISFACTION OF THE RECREATION & PARKS

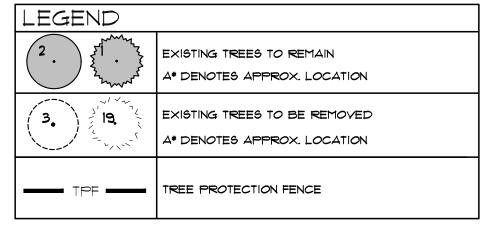



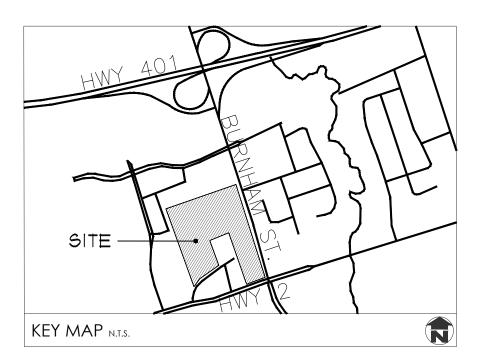


GENERAL NOTES

- ALL WORKMANSHIP WILL BE TO THE STANDARDS OF LANDSCAPE ONTARIO.
- 2. ALL PLANT MATERIAL TO BE NO.1 GRADE NURSERY GROWN IN ACCORDANCE WITH THE CANADIAN STANDARDS FOR NURSERY STOCK, 6TH EDITION, 1998, BY THE CANADIAN NURSERY TRADES
- 3. BACKFILL WILL CONSIST OF SOIL NATIVE TO THE SITE OR GENERAL SOIL TYPE/CLASS NATIVE TO THE SITE. TOPSOIL TO BE TESTED FOR NUTRIENT YALUE, AND AMENDED FOR OPTIMAL GROWTH AS PER THE RECOMMENDATIONS OF THE SOIL TEST.
- 4. CONTRACTOR SHALL MAINTAIN ALL LANDSCAPE AREAS UNTIL
- OWNER'S ACCEPTANCE OF PROJECT.
- 5. CONTRACTOR TO LOCATE ALL UNDERGROUND UTILITIES. 6. PLANTING MAY BE ADJUSTED TO SUIT LOCATIONS OF SITE UTILITY
- 1. ALL MATERIALS MUST BE APPROVED BY LANDSCAPE
- ARCHITECT PRIOR TO INSTALLATION. 8. SPREAD MULCH TO A MINIMUM OF 100mm COMPACTED DEPTH ON
- ALL TREE PITS AND PLANTING BEDS. 9. CHECK AND VERIFY ALL DIMENSIONS AND QUANTITIES PRIOR TO COMMENCEMENT OF WORK. ANY DISCREPANCIES ARE TO BE
- REPORTED IN WRITING TO THE LANDSCAPE ARCHITECT. QUANTITIES NOTED WITHIN THE PLAN SUPERCEDE THOSE IN THE PLANT LIST. ANY SUBSTITUTIONS SHALL BE APPROVED BY THE LANDSCAPE ARCHITECT.
- 10. SOD AS MARKED WITH NURSERY SOD ON A MINIMUM OF 100mm OF CLEAN TOPSOIL. FINE GRADE AND SOD ALL BOULEYARD AREAS TO MUNICIPAL SPECIFICATIONS AND REPAIR DAMAGE TO ADJACENT PROPERTIES, AS REQUIRED.
- 11. FINAL INSPECTION AND ACCEPTANCE OF PLANTING WORK SHALL COINCIDE WITH THE FINAL INSPECTION AND ACCEPTANCE OF ALL WORK INCLUDED IN THE CONTRACT. 12. ALL SEEDED SLOPES 3:1 AND GREATER TO RECEIVE EROSION
- CONTROL MATTING (COIR MAT, OR OTHER WILDLIFE FRIENDLY ALTERNATIVE). PIN SOD ON ALL SLOPES OF 3:1 OR GREATER.
- 13. SUBMIT A WRITTEN GUARANTEE TO THE EFFECT THAT ALL PLANTS ACCEPTED DURING THE PERIOD OF JANUARY 1st TO JULY 15th SHALL BE GUARANTEED UNTIL JULY 15th THE FOLLOWING YEAR PLANTS ACCEPTED DURING THE PERIOD OF JULY 15th TO DECEMBER 31st SHALL BE GUARANTEED FOR ONE YEAR FROM THE DATE OF ACCEPTANCE. THE GUARANTEE PERIODS LISTED ABOVE SHALL APPLY TO ALL "NURSERY GROWN" PLANTS.
- 14. AT THE TIME OF FINAL INSPECTION ALL PLANTS SHALL BE IN A HEALTHY, VIGOUROUS GROWING CONDITION, PLANTED IN FULL ACCORDANCE WITH DRAWINGS AND CONDITIONS.
- 15. SITE PLAN INFORMATION AS PER SALTER PILON ARCHITECTS
- 16. TOPOGRAPHIC OR EXISTING CONDITIONS INFORMATION AS PER LEA CONSULTING LTD., DATED SEPTEMBER 10, 2018.





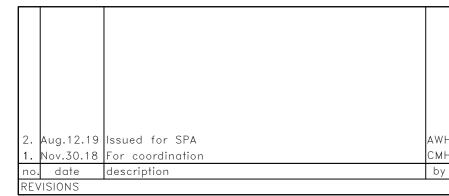

GOLDEN PLOUGH LODGE 555 COURTHOUSE ROAD TOWN OF COBOURG

Vegetation Management Plan



roviding Solutions in Urban, 🗼 🌞 andscape and Environmental Planning

550 Parkside Drive, Unit A-21, Waterloo, Ontario N2L 5V4 Tel. (519) 725-5**1**40 FAX (519) 725-5144

DRAWN BY:	DESIGNED BY:		APPROVED BY:
KLH	C	CMH	***
PROJECT NO.	SCALE:		DATE:
2018-36	1:7	750	October 26,2018
PLOTTED:	SHEET:		
August 12, 2019		L	1

EXISTIN	NG TREE LIST				
NO.	SPECIES	D.B.H	CONDITION	STATUS	ADDITIONAL NOTE
14.	Celtis occidentalis	15cm	Good	To be removed	Boundary tree
2.	Celtis occidentalis	20cm	Good	To be preserved	
3.	Celtis occidentalis	20cm	Good	To be removed	
4.	Celtis occidentalis	15cm 35cm	Fair	To be preserved	
5 <i>A.</i>	Acer platanoides		Good	To be preserved	
6 <i>A.</i>	Acer platanoides	35cm	Good	To be preserved	
7 <i>A.</i>	Acer platanoides	35cm	Good	To be removed	
8 <u>A.</u>	Acer platanoides	35cm	Good	To be preserved	
9.	Acer platanoides	15cm	Good	To be preserved	<u> </u>
10.	Acer platanoides	15cm 40cm	Good	To be preserved	Two trunks
11.	Acer platanoides	40cm	Fair	To be preserved	Trunk wound
12.	Acer platanoides	40cm 45cm	Fair	To be preserved	Leaf scorch
13.	Acer platanoides	45cm	Good	To be preserved	On adjacent property
14.	Acer platanoides	45cm	Good	To be preserved	On adjacent property
15.	Acer platanoides	45cm	Good	To be preserved	On adjacent property
16.	Acer platanoides		Good	To be preserved	On adjacent property
17.	Acer platanoides	45cm	Good	To be preserved	On adjacent property
18.	Acer platanoides	40cm	Good	To be removed	Boundary tree, leaf scorch
19.	Malus rosaceae	40cm	Good	To be removed	Leaning
2 <i>Ø.</i>	Acer platanoides	50cm	Good	To be removed	Black spot
21.	Acer rubrum	35cm	Good	To be removed	1
22 <i>A.</i>	Juglans nigra	25cm	Good	To be removed	Two trunks
23.	Fraxinus sp.	15cm	Good	To be preserved	Trunk damage
24.	Fraxinus sp.	35cm	Good	To be preserved	Boundary tree
25 <i>.</i>	Acer saccharinum	+65cm	Good	To be preserved	Co-dominate stems within bark
26.	Acer saccharinum	+65cm	Good	To be preserved	Co-dominate stems within bark
27 <i>.</i>	Tilia cordata	+65cm	Good	To be removed	1
2 <i>8.</i>	Tilia cordata	45cm	Good	To be preserved	1
29.	Tilia cordata	45cm	Good	To be preserved	
3 <i>0.</i>	Tilia cordata	45cm	Good	To be preserved	
31.	Tilia cordata	55cm	Good	To be preserved	
32 <i>A.</i>	Pinus mugo	45cm	Good	To be preserved	
33 <i>A.</i>	Pinus mugo	45cm	Good	To be preserved	
34 <i>A.</i>	Pinus mugo	45cm	Good	To be removed	
35 <i>.</i>	Acer rubrum	25cm	Good	To be preserved	
36 <i>.</i>	Acer rubrum	20cm	Fair	To be preserved	Trunk wounds
37 <i>.</i>	Acer rubrum	15cm	Good	To be preserved	
38.	Acer rubrum	15cm	Good	To be preserved	
39.	Acer rubrum	30cm	Good	To be preserved	
40.	Acer platanoides	45cm	Good	To be preserved	
41.	Acer platanoides	35cm	Good	To be preserved	
42.	Acer rubrum	25cm	Fair	To be preserved	
43 <i>.</i>	Malus rosaceae	25cm	Fair	To be removed	On adjacent property
44.	Malus rosaceae	25cm 25cm	Fair	To be removed	On adjacent property
45. 46	Acer rubrum	25cm	Good	To be preserved	
46. 47.	Acer rubrum Acer rubrum	40cm	Good	To be preserved	Co-dominant stems within bark
4 1. 48.	Acer rubrum	25cm	Fair	To be preserved To be removed	
<u>49.</u> 49.	Betula papyrifera	25cm	Good	To be removed	On adjacent property
- 3. 50.	Betula papyrifera	25cm	Good	To be removed	
51.	Acer rubrum	25cm	Good	To be preserved	
52 <i>.</i>	Malus rosaceae	25cm	Fair	To be removed	
52. 53.	Acer rubrum	15cm	Good		
5 <i>3.</i> 54.	T ACEL LADIAN		1 4000	To be preserved To be removed	
er fo	Acer rubrum	1460cm	Fair		
55	Acer rubrum	40cm	Fair		
	Malus rosaceae	25cm	Good	To be removed	Leaning
56 <i>A.</i>	Malus rosaceae Pinus mugo	25cm 35cm	Good Fair	To be removed To be removed	Leaning
56 <i>A.</i> 57.	Malus rosaceae Pinus mugo Malus rosaceae	25cm 35cm 15cm	Good Fair Good	To be removed To be removed To be removed	Leaning
56 <i>A.</i> 57. 58 <i>A.</i>	Malus rosaceae Pinus mugo Malus rosaceae Pinus mugo	25cm 35cm	Good Fair Good Good	To be removed To be removed To be removed To be removed	Leaning
56 <i>A.</i> 57. 58 <i>A.</i> 59 <i>A.</i>	Malus rosaceae Pinus mugo Malus rosaceae Pinus mugo Pinus mugo	25cm 35cm 15cm 35cm	Good Fair Good Good Good	To be removed To be removed To be removed To be removed To be preserved	Leaning
56 <i>A.</i> 57. 58 <i>A.</i> 59 <i>A.</i> 60 <i>A.</i>	Malus rosaceae Pinus mugo Malus rosaceae Pinus mugo Pinus mugo Pinus mugo	25cm 35cm 15cm 35cm	Good Fair Good Good Good	To be removed To be removed To be removed To be removed To be preserved To be removed	Leaning
56 A. 57. 58 A. 59 A. 60 A.	Malus rosaceae Pinus mugo Malus rosaceae Pinus mugo Pinus mugo Pinus mugo Pinus mugo Pinus mugo	25cm 35cm 15cm 35cm 35cm	Good Fair Good Good Good Fair	To be removed To be removed To be removed To be removed To be preserved To be removed To be removed	Leaning
56 A. 57. 58 A. 59 A. 60 A. 61 A.	Malus rosaceae Pinus mugo Malus rosaceae Pinus mugo Pinus mugo Pinus mugo Pinus mugo Pinus mugo Pinus mugo	25cm 35cm 15cm 35cm 35cm 35cm	Good Fair Good Good Good Fair Good	To be removed To be removed To be removed To be removed To be preserved To be preserved To be preserved To be preserved	Leaning
56 A. 57. 58 A. 59 A. 60 A. 61 A. 62 A.	Malus rosaceae Pinus mugo Malus rosaceae Pinus mugo	25cm 35cm 15cm 35cm 35cm 35cm 35cm 25cm	Good Fair Good Good Good Fair Good Good Fair	To be removed To be removed To be removed To be removed To be preserved	Leaning
56 A. 57. 58 A. 59 A. 60 A. 61 A. 62 A. 63 A.	Malus rosaceae Pinus mugo Malus rosaceae Pinus mugo	25cm 35cm 15cm 35cm 35cm 35cm 25cm 35cm	Good Fair Good Good Good Fair Good Good Good Good	To be removed To be removed To be removed To be removed To be preserved	Leaning
56 A. 57. 58 A. 59 A. 60 A. 61 A. 62 A. 63 A. 64 A.	Malus rosaceae Pinus mugo Malus rosaceae Pinus mugo	25cm 35cm 15cm 35cm 35cm 35cm 25cm 25cm 40cm	Good Fair Good Good Good Fair Good Good Fair	To be removed To be removed To be removed To be removed To be preserved	Leaning
56 A. 57. 58 A. 59 A. 60 A. 61 A. 62 A. 63 A. 64 A. 65 A.	Malus rosaceae Pinus mugo Malus rosaceae Pinus mugo	25cm 35cm 15cm 35cm 35cm 35cm 35cm 35cm 45cm	Good Fair Good Good Good Fair Good Good Good Good Fair Good Good Fair	To be removed To be removed To be removed To be preserved	Leaning
56 A. 57. 58 A. 59 A. 60 A. 61 A. 63 A. 64 A. 65 A. 66 A. 61 A.	Malus rosaceae Pinus mugo Malus rosaceae Pinus mugo	25cm 35cm 15cm 35cm 35cm 35cm 35cm 35cm 40cm 45cm	Good Fair Good Good Good Fair Good Good Good Good Good Good Good Goo	To be removed To be removed To be removed To be removed To be preserved To be removed To be removed To be removed	Leaning
56 A. 57. 58 A. 59 A. 60 A. 61 A. 62 A. 63 A. 64 A. 65 A. 66 A. 67 A.	Malus rosaceae Pinus mugo Malus rosaceae Pinus mugo	25cm 35cm 15cm 35cm 35cm 35cm 35cm 35cm 40cm 45cm 45cm 55cm	Good Fair Good Good Good Fair Good Good Good Good Good Good Good Goo	To be removed To be removed To be removed To be preserved To be removed To be removed To be removed	Leaning
56 A. 57. 58 A. 59 A. 60 A. 61 A. 63 A. 65 A. 65 A. 66 A. 67 A. 68 A.	Malus rosaceae Pinus mugo Malus rosaceae Pinus mugo	25cm 35cm 15cm 35cm 35cm 35cm 35cm 25cm 40cm 45cm 45cm	Good Fair Good Good Good Good Good Good Good Goo	To be removed To be removed To be removed To be removed To be preserved To be removed	
56 A. 57. 58 A. 59 A. 50 A. 51 A. 52 A. 53 A. 54 A. 55 A. 56 A. 57 A. 58 A.	Malus rosaceae Pinus mugo Malus rosaceae Pinus mugo	25cm 35cm 15cm 35cm 35cm 35cm 35cm 25cm 40cm 45cm 45cm 45cm 45cm 45cm 45cm	Good Fair Good Good Good Good Good Good Good Goo	To be removed To be removed To be removed To be removed To be preserved To be removed	Leaning In planter
56 A. 57. 58 A. 59 A. 60 A. 61 A. 62 A. 64 A. 65 A. 66 A. 67 A. 68 A. 69.	Malus rosaceae Pinus mugo Malus rosaceae Pinus mugo	25cm 35cm 15cm 35cm 35cm 35cm 35cm 35cm 25cm 40cm 45cm 45cm 45cm 45cm 45cm	Good Fair Good Good Good Good Good Good Good Goo	To be removed To be removed To be removed To be removed To be preserved To be removed To be preserved To be removed To be preserved To be preserved To be preserved To be preserved	In planter
56 A. 57. 58 A. 59 A. 51 A. 52 A. 53 A. 54 A. 55 A. 56 A. 57 A. 58 A. 10 A.	Malus rosaceae Pinus mugo Malus rosaceae Pinus mugo Picea pungens Malus rosaceae Ulmus sp. Gleditsia triacanthos Acer platanoides Amelanchier canadensis	25cm 35cm 15cm 35cm 35cm 35cm 35cm 35cm 25cm 40cm 45cm 45cm 45cm 45cm 45cm 165cm 45cm	Good Fair Good Good Good Good Good Good Good Goo	To be removed To be removed To be removed To be removed To be preserved To be removed To be preserved	In planter Clump
56 A. 57. 58 A. 59 A. 50 A. 61 A. 62 A. 63 A. 65 A. 65 A. 67 A. 69. 10 A. 11. 12 A.	Malus rosaceae Pinus mugo Malus rosaceae Pinus mugo Picea pungens Malus rosaceae Ulmus sp. Gleditsia triacanthos Acer platanoides Amelanchier canadensis Thuja occidentalis	25cm 35cm 15cm 35cm 35cm 35cm 35cm 25cm 35cm 40cm 45cm 45cm 45cm 45cm 35cm 10-25cm	Good Fair Good Good Good Good Good Good Good Goo	To be removed To be removed To be removed To be removed To be preserved To be removed To be preserved	In planter
56 A. 57. 58 A. 59 A. 60 A. 61 A. 63 A. 65 A. 66 A. 67 A. 69. 10 A. 11. 12 A. 13.	Malus rosaceae Pinus mugo Malus rosaceae Pinus mugo Picea pungens Malus rosaceae Ulmus sp. Gleditsia triacanthos Acer platanoides Amelanchier canadensis Thuja occidentalis Malus rosaceae	25cm 35cm 15cm 35cm 35cm 35cm 35cm 35cm 25cm 40cm 45cm 45cm 45cm 45cm 45cm 45cm 10-25cm 50cm	Good Fair Good Good Good Good Good Good Good Goo	To be removed To be removed To be removed To be removed To be preserved To be removed To be preserved	In planter Clump
56 A. 57. 58 A. 59 A. 60 A. 61 A. 63 A. 65 A. 66 A. 67 A. 68 A. 10 A. 11. 12 A. 13. 14.	Malus rosaceae Pinus mugo Malus rosaceae Pinus mugo Pin	25cm 35cm 15cm 35cm 35cm 35cm 35cm 25cm 35cm 40cm 45cm 45cm 45cm 45cm 35cm 10-25cm 50cm 20cm	Good Fair Good Good Good Good Good Good Good Goo	To be removed To be removed To be removed To be removed To be preserved To be removed To be preserved	In planter Clump
56A. 57. 58A. 59A. 60A. 61A. 62A. 63A. 65A. 66A. 67A. 68A. 69. 10A. 11. 12A. 13. 14.	Malus rosaceae Pinus mugo Malus rosaceae Pinus mugo Picea pungens Malus rosaceae Ulmus sp. Gleditsia triacanthos Acer platanoides Amelanchier canadensis Thuja occidentalis Malus rosaceae Malus rosaceae Malus rosaceae	25cm 35cm 15cm 35cm 35cm 35cm 35cm 25cm 25cm 40cm 45cm 45cm 45cm 45cm 45cm 45cm 45cm 25cm 40cm 45cm 45cm 45cm 45cm 45cm 45cm 45cm 45	Good Fair Good Good Good Good Good Good Good Goo	To be removed To be removed To be removed To be preserved To be removed To be preserved	In planter Clump
56 A. 57. 58 A. 59 A. 60 A. 61 A. 62 A. 64 A. 65 A. 66 A. 67 A. 68 A. 10 A. 11. 12 A. 13. 14. 15. 16.	Malus rosaceae Pinus mugo Malus rosaceae Pinus mugo Pin	25cm 35cm 15cm 35cm 35cm 35cm 35cm 25cm 35cm 40cm 45cm 45cm 45cm 35cm 10-25cm 50cm 20cm 20cm 20cm 35cm	Good Fair Good Good Good Good Good Good Good Goo	To be removed To be removed To be removed To be preserved To be removed To be preserved	In planter Clump
56 A. 57. 58 A. 59 A. 60 A. 61 A. 63 A. 65 A. 65 A. 66 A. 67 A. 69. 10 A. 11. 12 A. 15. 16. 17.	Malus rosaceae Pinus mugo Malus rosaceae Pinus mugo Picea pungens Malus rosaceae Ulmus sp. Gleditsia triacanthos Acer platanoides Amelanchier canadensis Thuja occidentalis Malus rosaceae Malus rosaceae Malus rosaceae Malus rosaceae Acer saccharinum	25cm 35cm 15cm 35cm 35cm 35cm 35cm 25cm 35cm 40cm 45cm 45cm 55cm 35cm 405cm 20cm 20cm 20cm 35cm 30cm	Good Fair Good Good Good Good Good Good Good Goo	To be removed To be removed To be removed To be preserved To be removed To be preserved	In planter Clump
56 A. 57. 58 A. 59 A. 60 A. 61 A. 63 A. 65 A. 65 A. 68 A. 69. 10 A. 11. 12 A. 13. 14. 15. 16. 17.	Malus rosaceae Pinus mugo Malus rosaceae Pinus mugo Picea pungens Malus rosaceae Ulmus sp. Gleditsia triacanthos Acer platanoides Amelanchier canadensis Thuja occidentalis Malus rosaceae Malus rosaceae Malus rosaceae Malus rosaceae Malus rosaceae Malus rosaceae Acer saccharinum Acer saccharinum	25cm 35cm 15cm 35cm 35cm 35cm 35cm 25cm 35cm 40cm 45cm 45cm 45cm 45cm 35cm 40cm 45cm 25cm 25cm 25cm 25cm 25cm	Good Fair Good Good Good Good Good Good Good Goo	To be removed To be removed To be removed To be preserved To be removed To be removed To be removed To be removed To be preserved	In planter Clump
56 A. 57. 58 A. 59 A. 60 A. 61 A. 62 A. 65 A. 65 A. 65 A. 67 A. 11. 12 A. 13. 14. 15. 16. 17. 18. 19.	Malus rosaceae Pinus mugo Malus rosaceae Pinus mugo Picea pungens Malus rosaceae Ulmus sp. Gleditsia triacanthos Acer platanoides Amelanchier canadensis Thuja occidentalis Malus rosaceae Malus rosaceae Malus rosaceae Malus rosaceae Acer saccharinum Acer saccharinum Picea abies	25cm 35cm 15cm 35cm 35cm 35cm 35cm 25cm 35cm 40cm 45cm 45cm 45cm 45cm 35cm 40cm 25cm 25cm 35cm 40cm 25cm 35cm	Good Fair Good Good Good Good Good Good Good Goo	To be removed To be removed To be removed To be preserved To be removed To be removed To be removed To be removed To be preserved	In planter Clump
56 A. 57. 58 A. 59 A. 60 A. 61 A. 62 A. 64 A. 65 A. 66 A. 67 A. 11. 12 A. 13. 14. 15. 16. 17. 18. 19. 180 A. 81.	Malus rosaceae Pinus mugo Malus rosaceae Pinus mugo Picea pungens Malus rosaceae Ulmus sp. Gleditsia triacanthos Acer platanoides Amelanchier canadensis Thuja occidentalis Malus rosaceae Malus rosaceae Malus rosaceae Malus rosaceae Malus rosaceae Acer saccharinum Acer saccharinum Picea abies Acer saccharinum	25cm 35cm 15cm 35cm 35cm 35cm 35cm 25cm 25cm 40cm 45cm 45cm 45cm 45cm 45cm 25cm 25cm 25cm 20cm 20cm 20cm 20cm 20cm 20cm 25cm 25cm	Good Fair Good Good Good Good Good Good Good Goo	To be removed To be removed To be removed To be preserved To be removed To be removed To be removed To be removed To be preserved	In planter Clump
56 A. 57. 58 A. 59 A. 69 A. 61 A. 62 A. 63 A. 65 A. 65 A. 67 A. 67 A. 11. 12 A. 13. 14. 15. 16. 17. 18. 19. 18. 19. 18. 19.	Malus rosaceae Pinus mugo Malus rosaceae Pinus mugo Picea pungens Malus rosaceae Ulmus sp. Gleditsia triacanthos Acer platanoides Amelanchier canadensis Thuja occidentalis Malus rosaceae Malus rosaceae Malus rosaceae Malus rosaceae Acer saccharinum Acer saccharinum Picea abies Acer saccharinum Acer saccharinum	25cm 35cm 15cm 35cm 35cm 35cm 35cm 25cm 35cm 40cm 45cm 45cm 45cm 45cm 35cm 405cm 25cm 20cm 20cm 20cm 20cm 20cm 20cm 20cm 20	Good Fair Good Good Good Good Good Good Good Goo	To be removed To be removed To be removed To be preserved To be removed To be preserved	In planter Clump
56 A. 57. 58 A. 59 A. 60 A. 61 A. 62 A. 65 A. 65 A. 65 A. 66 A. 67 A. 11. 12 A. 13. 14. 15. 16. 17. 18. 19. 30 A. 31. 32. 33.	Malus rosaceae Pinus mugo Malus rosaceae Pinus mugo Picea pungens Malus rosaceae Ulmus sp. Gleditsia triacanthos Acer platanoides Amelanchier canadensis Thuja occidentalis Malus rosaceae Malus rosaceae Malus rosaceae Malus rosaceae Acer saccharinum Acer saccharinum Acer saccharinum Acer saccharinum Acer saccharinum Acer saccharinum	25cm 35cm 15cm 35cm 35cm 35cm 35cm 25cm 35cm 40cm 45cm 45cm 55cm 35cm 465cm 25cm 20cm 20cm 20cm 20cm 20cm 20cm 20cm 20	Good Fair Good Good Good Good Good Good Good Goo	To be removed To be removed To be removed To be preserved To be preserved To be preserved To be preserved To be removed To be preserved	In planter Clump
56A. 57. 58A. 59A. 60A. 61A. 62A. 63A. 65A. 65A. 66A. 67A. 11. 12A. 13. 14. 15. 16. 17. 18. 19. 80A. 81. 82. 83.	Malus rosaceae Pinus mugo Malus rosaceae Pinus mugo Picea pungens Malus rosaceae Ulmus sp. Gleditsia triacanthos Acer platanoides Amelanchier canadensis Thuja occidentalis Malus rosaceae Malus rosaceae Malus rosaceae Malus rosaceae Malus rosaceae Acer saccharinum	25cm 35cm 15cm 35cm 35cm 35cm 35cm 35cm 25cm 35cm 40cm 45cm 45cm 55cm 35cm 405cm 25cm 25cm 35cm 405cm 25cm 35cm 45cm 35cm 45cm 35cm 45cm 35cm 45cm 35cm 45cm 35cm 35cm 20cm 20cm 20cm 20cm 20cm 20cm 35cm 30cm 35cm 30cm 35cm	Good Fair Good Good Good Good Good Good Good Goo	To be removed To be removed To be removed To be preserved To be removed To be preserved To be preserved	In planter Clump 30% dead
55. 56A. 57. 58A. 59A. 60A. 61A. 62A. 63A. 65A. 65A. 65A. 67A. 11. 12A. 13. 14. 15. 16. 17. 18. 19. 80A. 81. 82. 83. 84.	Malus rosaceae Pinus mugo Malus rosaceae Pinus mugo Picea pungens Malus rosaceae Ulmus sp. Gleditsia triacanthos Acer platanoides Amelanchier canadensis Thuja occidentalis Malus rosaceae Malus rosaceae Malus rosaceae Malus rosaceae Acer saccharinum Acer saccharinum Acer saccharinum Acer saccharinum Acer saccharinum Acer saccharinum	25cm 35cm 15cm 35cm 35cm 35cm 35cm 25cm 35cm 40cm 45cm 45cm 55cm 35cm 465cm 25cm 20cm 20cm 20cm 20cm 20cm 20cm 20cm 20	Good Fair Good Good Good Good Good Good Good Goo	To be removed To be removed To be removed To be preserved To be preserved To be preserved To be preserved To be removed To be preserved	In planter Clump

D.	SPECIES	D.B.H	CONDITION	STATUS	ADDITIONAL NOTE
٦ <i>.</i>	Ulmus pumila	+65cm	Fair	To be preserved	40% dead, trunk damage
38.	Acer platanoides	45cm	Good	To be preserved	Co-dominant stems within bark
39.	Ulmus pumila	+65cm	Fair	To be preserved	Trunk damage
3Ø.	Acer saccharinum	20cm	Fair	To be preserved	
91.	Acer saccharinum	20cm	Good	To be preserved	
92.	Malus rosaceae	15cm	Good	To be removed	
93.	Gleditsia triacanthos	25cm	Good	To be preserved	
944.	Pinus glauca	20cm	Fair	To be preserved	Scale on lower 30%
95.	Malus rosaceae	15cm	Good	To be removed	
96.	Malus rosaceae	15cm	Good	To be removed	
97.	Gleditsia triacanthos	25cm	Good	To be preserved	
9 <i>8.</i>	Acer saccharum	25cm	Good	To be removed	
99.	Jugans nigra	+65cm	Good	To be removed	
100.	Acer saccharum	25cm	Fair	To be removed	Trunk wounds
101.	Malus rosaceae	15cm	Good	To be removed	
102.	Malus rosaceae	15cm	Good	To be preserved	
1Ø3A.	Picea glauca	15cm	Good	To be preserved	
104.	Quercus rubrum	15cm	Good	To be removed	In construction zone
105.	Nyssa sylvatica	15cm	Good	To be preserved	
106.	Gingko biloba	15cm	Good	To be preserved	
1Ø7.	Gingko biloba	20cm	Good	To be preserved	
108.	Gingko biloba	20cm	Good	To be preserved	
109.	Gingko biloba	20cm	Good	To be preserved	
110.	Quercus rubrum	20cm	Good	To be preserved	
111.	Malus rosaceae	20cm	Good	To be removed	
112.	Quercus rubrum	25cm	Good	To be preserved	
113.	Quercus rubrum	25cm	Good	To be preserved	
1144.	Acer platanoides	55cm	Good	To be removed	Co-dominant stems within bark
115.	Quercus rubrum	20cm	Good	To be preserved	
1164.	Picea glauca	40cm	Fair	To be removed	Suppressed on one side
רוו.	Quercus rubrum	20cm	Good	To be removed	
1184.	Picea glauca	45cm	Good	To be removed	Suppressed on one side
119.	Quercus rubrum	20cm	Good	To be preserved	
120.	Quercus rubrum	25cm	Good	To be preserved	
121 <i>A.</i>	Sorbus decora	10-25cm	Good	To be removed	Multi-trunk
122 <i>A.</i>	Picea glauca	30cm	Good	To be removed	
123 <i>A.</i>	Juglans nigra	60cm	Good	To be preserved	
124 <i>A.</i>	Juglans nigra	60cm	Good	To be preserved	
125 <i>A.</i>	Juglans nigra	35cm	Good	To be preserved	
126 <i>A.</i>	Juglans nigra	55cm	Good	To be preserved	
127 <i>A.</i>	Juglans nigra	35cm	Good	To be preserved	
128.	Prunus sp.	15cm	Fair	To be removed	Sucker from stump
1294.	Acer platanoides	30cm	Fair	To be removed	Suppressed on one side
130.	Thuja occidentalis	45cm	Fair	To be preserved	
1314.	Thuja occidentalis	45cm	Fair	To be preserved	
132 <i>A.</i>	Thuja occidentalis	45cm	Fair	To be removed	
133.	Acer saccharum	30cm	Fair	To be removed	
134 <i>A.</i>	Prunus virginiana	10-20cm	Fair	To be removed	Clump
135 <i>A.</i>	Juglans nigra	25cm	Good	To be removed	
136.	Gleditsia triacanthos	15cm	Good	To be removed	
13T.	Cercidiphyllum japonicum	15cm	Good	To be preserved	
138A.	Juglans nigra	15cm	Fair	To be removed	
139 <i>A.</i>	Jugians nigra	25cm	Fair	To be removed	
14ØA.	Juglans nigra	25cm	Fair	To be removed	
I4IA.	Acer negundo	45cm	Fair	To be preserved	Broken limb
42 <i>A</i> .	Acer negundo	45cm	Fair	To be preserved	Broken limb
		1	-	'	



2. Aug.12.19 Issued for SPA
1. Nov.30.18 For coordination
CMH
no. date description by
REVISIONS

GOLDEN PLOUGH LODGE 555 COURTHOUSE ROAD TOWN OF COBOURG


Tree Inventory


Mackinnon & Associates a division of 907216 Ontario Inc.

Providing Solutions in Urban, # _andscape and Environmental Planning

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DRAWN BY:	DESIGNED BY	':	APPRO	VED BY:
KLH		CMH		***
PROJECT NO.	SCALE:		DATE:	
2018-36		As Noted		October 26, 2018
PLOTTED:	SHEET:		'	
August 12, 2019		L	2	



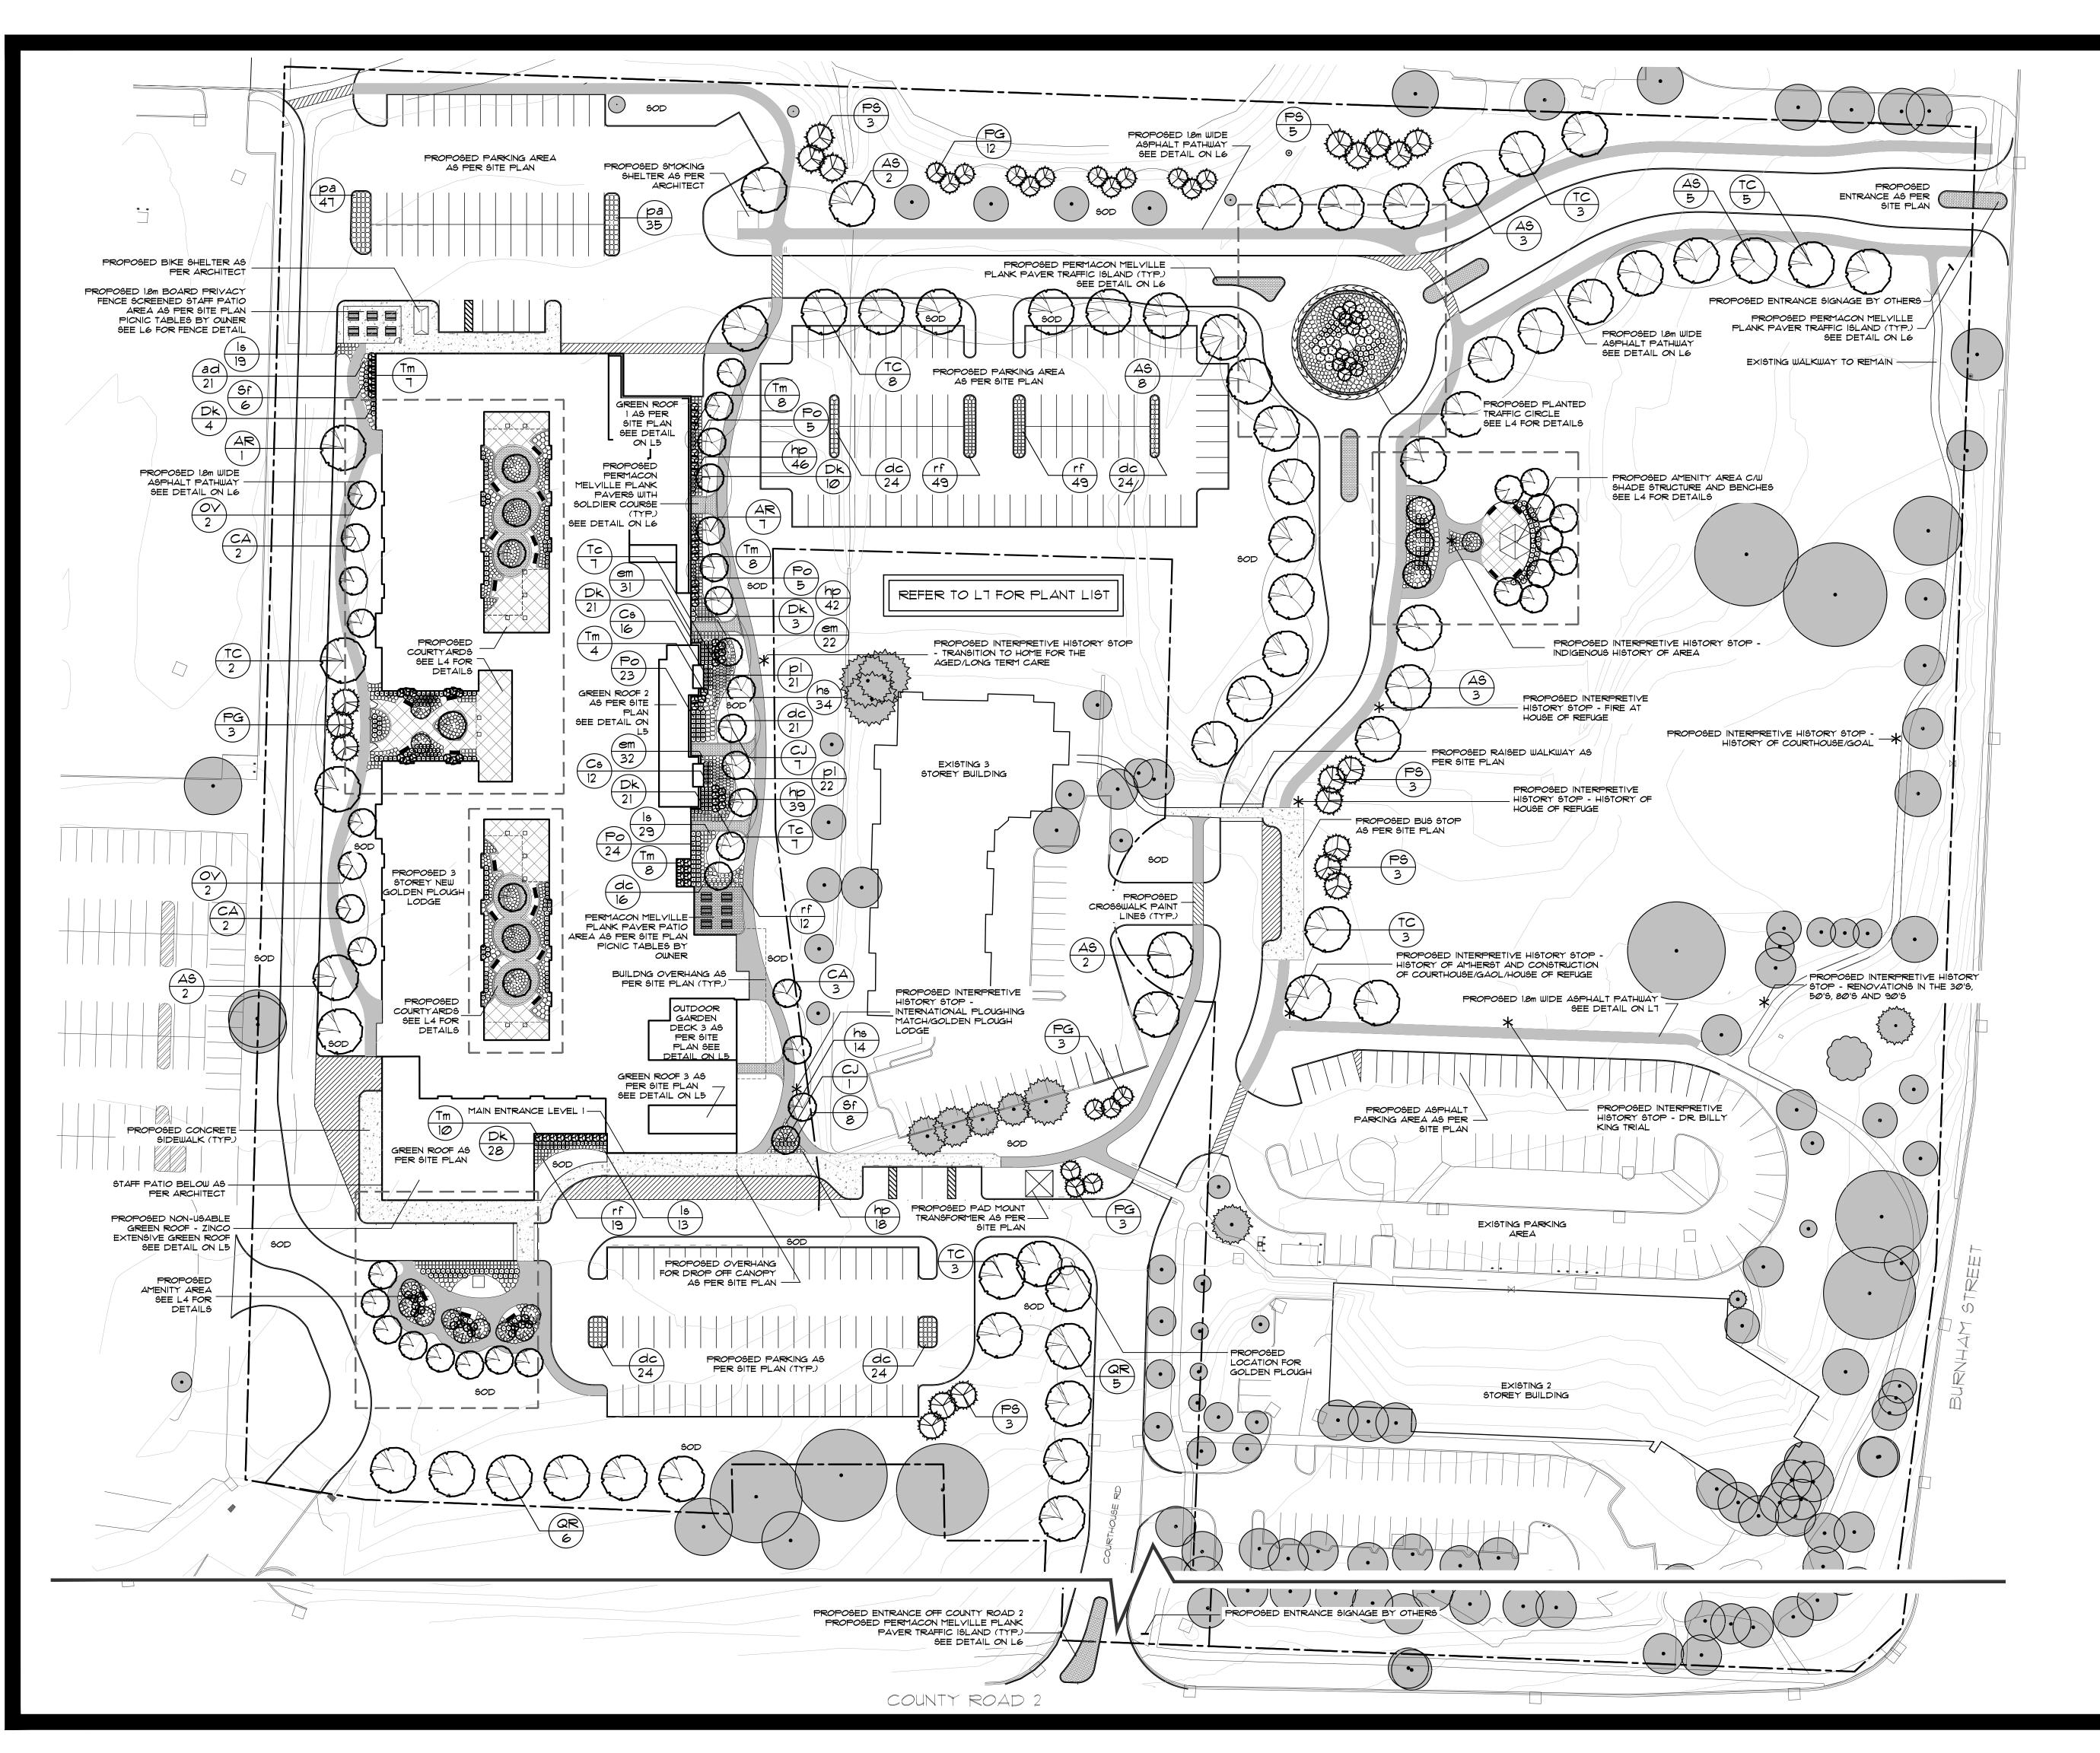


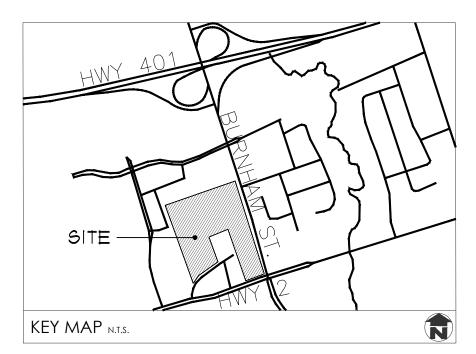GENERAL NOTES

- 1. ALL WORKMANSHIP WILL BE TO THE STANDARDS OF LANDSCAPE
- 2. ALL PLANT MATERIAL TO BE NO.1 GRADE NURSERY GROWN IN ACCORDANCE WITH THE CANADIAN STANDARDS FOR NURSERY STOCK, 6TH EDITION, 1998, BY THE CANADIAN NURSERY TRADES ASSOCIATION.
- 3. BACKFILL WILL CONSIST OF SOIL NATIVE TO THE SITE OR GENERAL SOIL TYPE/CLASS NATIVE TO THE SITE. TOPSOIL TO BE TESTED FOR NUTRIENT VALUE, AND AMENDED FOR OPTIMAL GROWTH AS PER THE RECOMMENDATIONS OF THE SOIL TEST.
- 4. CONTRACTOR SHALL MAINTAIN ALL LANDSCAPE AREAS UNTIL OWNER'S ACCEPTANCE OF PROJECT.
- 5. CONTRACTOR TO LOCATE ALL UNDERGROUND UTILITIES.
- 6. PLANTING MAY BE ADJUSTED TO SUIT LOCATIONS OF SITE UTILITY STRUCTURES/SERVICES.
- ALL MATERIALS MUST BE APPROVED BY LANDSCAPE ARCHITECT PRIOR TO INSTALLATION.
- 8. SPREAD MULCH TO A MINIMUM OF 100mm COMPACTED DEPTH ON ALL TREE PITS AND PLANTING BEDS.
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GOLDEN PLOUGH LODGE 555 COURTHOUSE ROAD TOWN OF COBOURG


Landscape Plan

MacKinnon & Associates
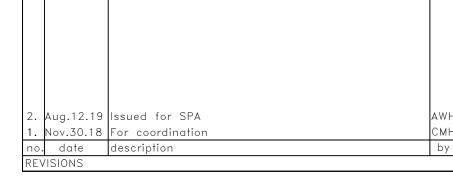
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550 Parkside Drive, Unit A-21, Waterloo, Ontario N2L 5V4
Tel. (519) 725-5140 FAX (519) 725-5144

DRAWN BY:	DESIGNED BY	:	APPROVED BY:
BH/KLH		CMH/AWH	***
PROJECT NO.	SCALE:		DATE:
2018-36		1:500	July 2018
PLOTTED:	SHEET:		
August 12, 2019		1	3

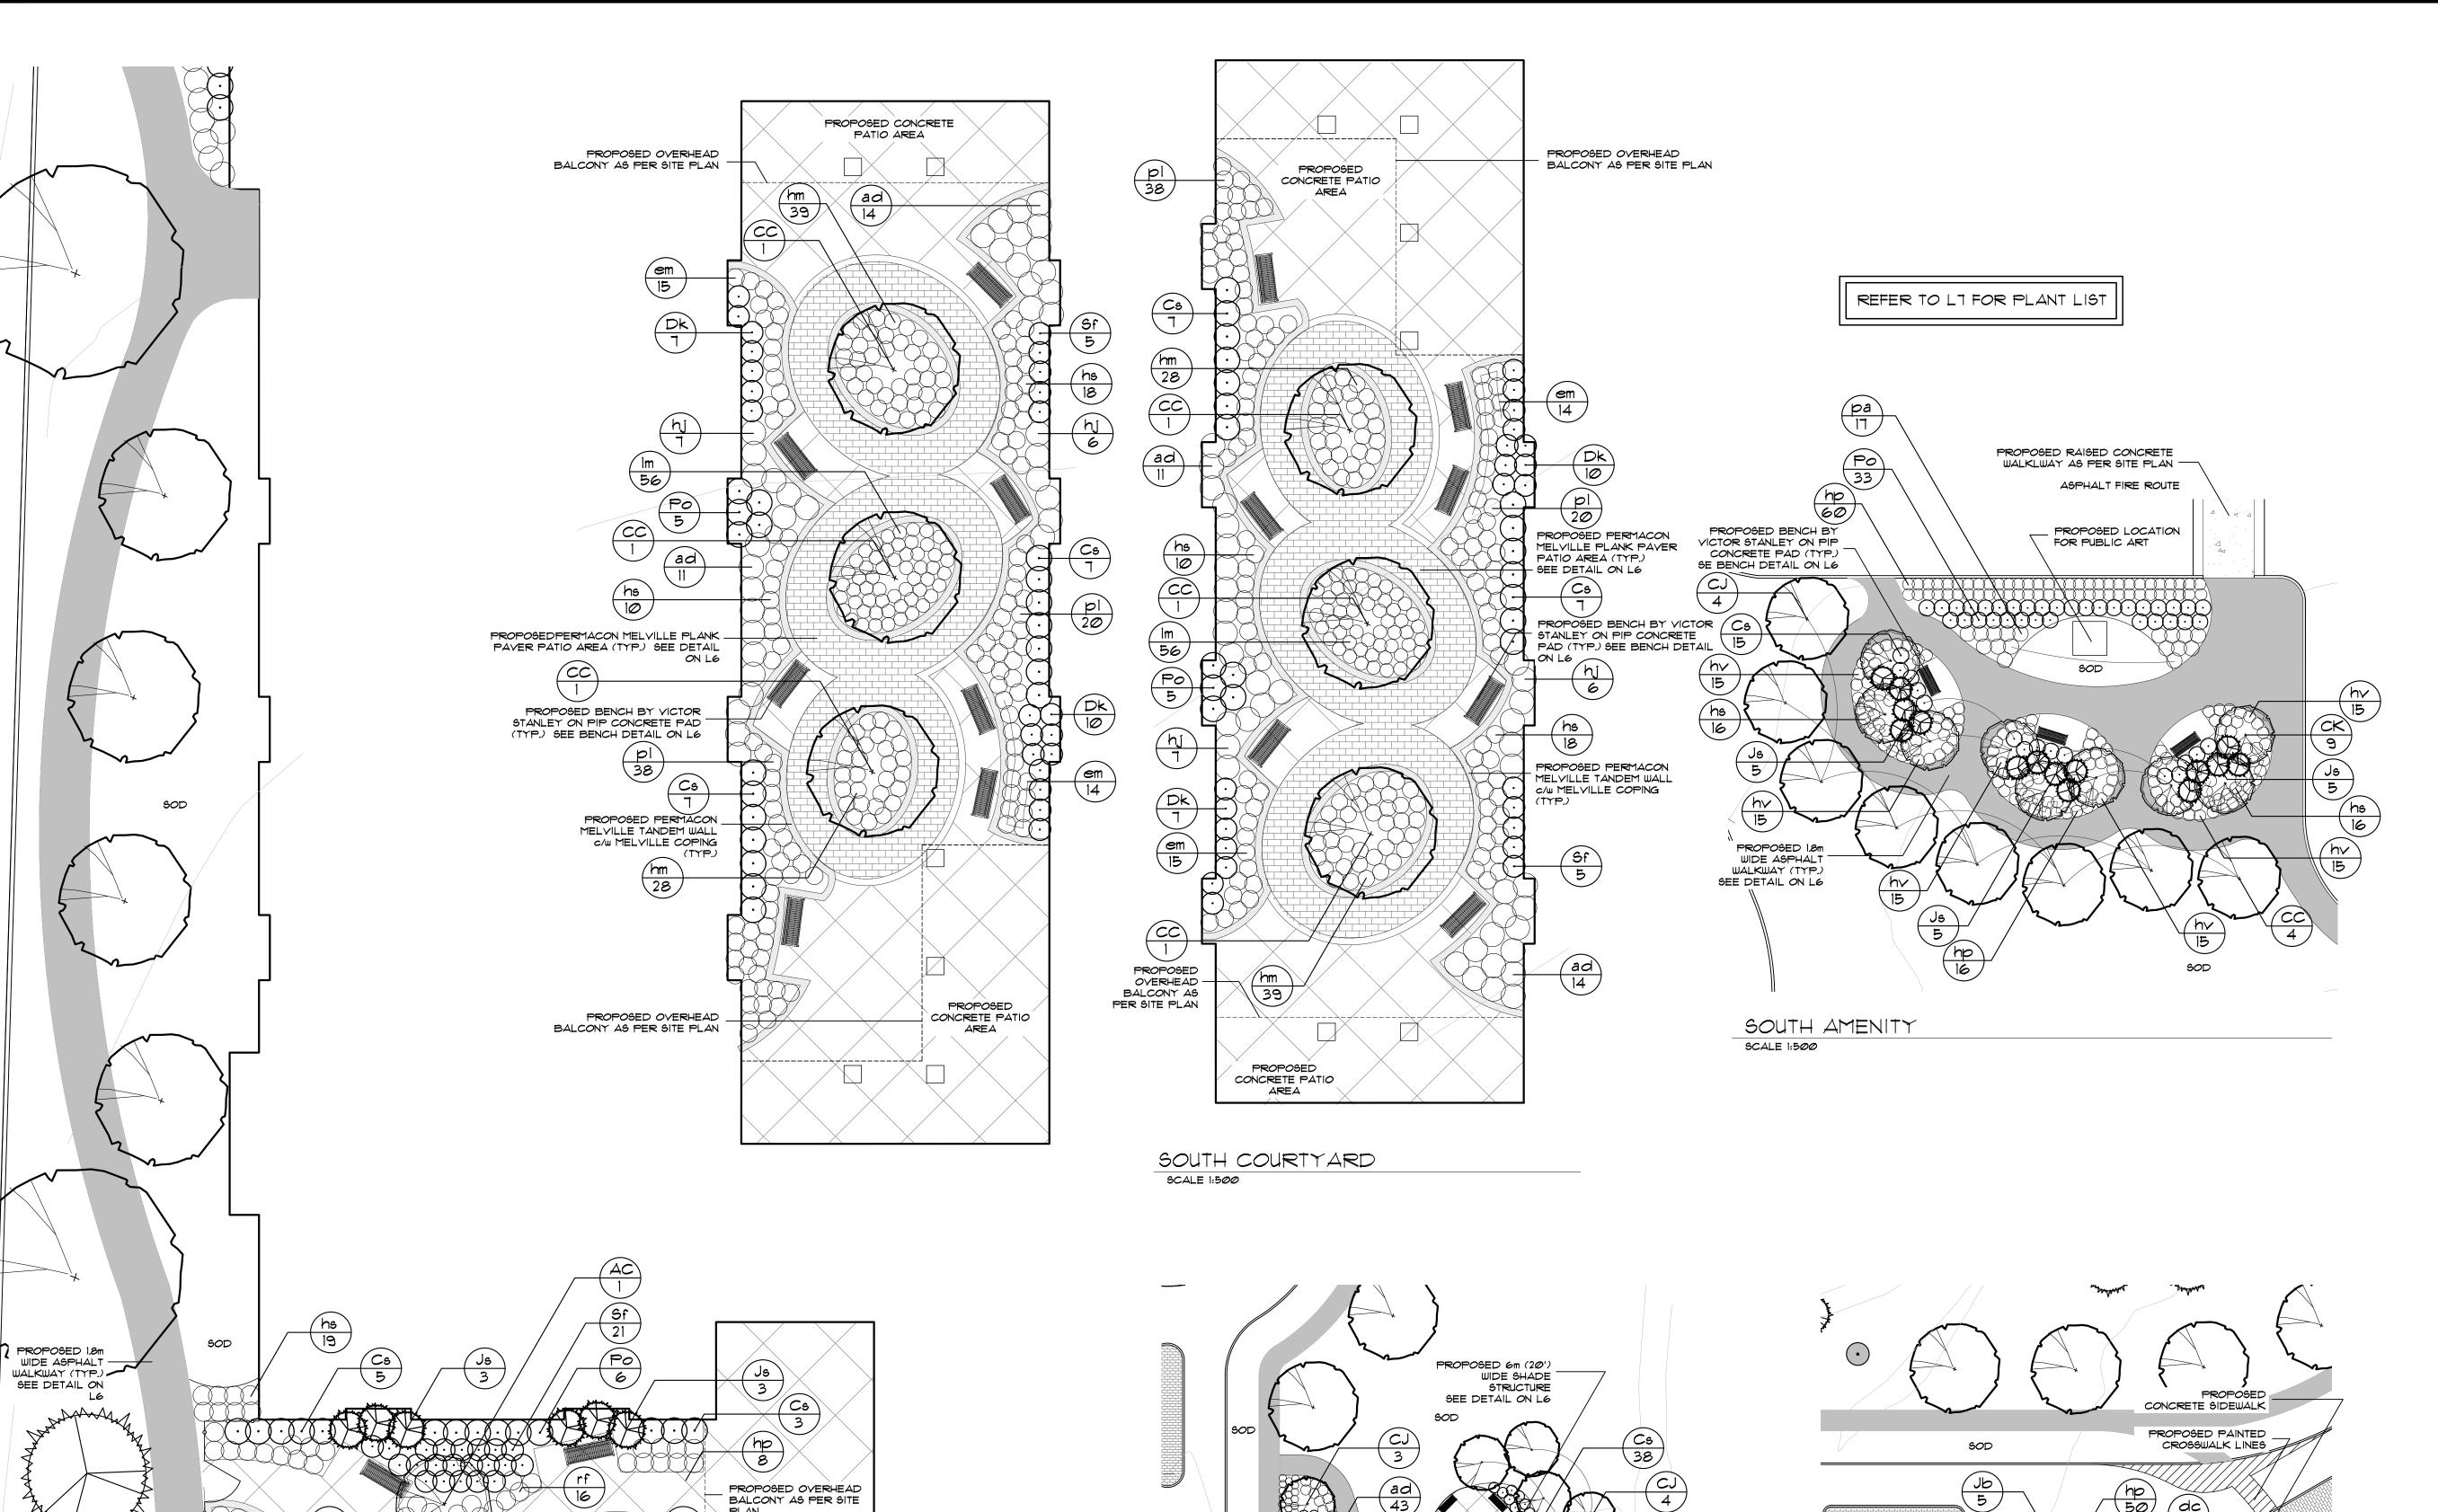

PROPOSED INTERPRETIVE
HISTORY STOP - INDIGENOUS
HISTORY OF AREA —
INTERPRETIVE SIGN
INSTALLED IN GARDEN BED

GREAT LAWN AMENITY

PROPOSED PERMACON - MELVILLE TANDEM WALL c/w MELVILLE COPING

PROPOSED CONCRETE PATIO

Cs


PROPOSED BENCH BY _ VICTOR STANLEY (TYP.) SEE DETAIL ON L6

PROPOSED PERMACON
-MELVILLE TANDEM WALL

C/W MELVILLE COPING

hs 20

NORTH AND WEST COURTYARDS

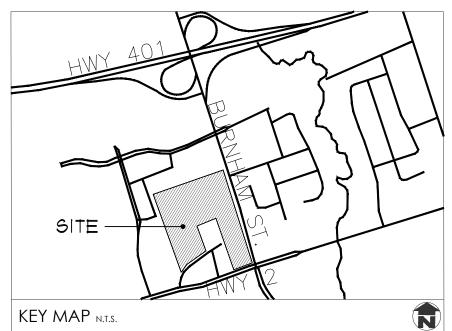


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GOLDEN PLOUGH LODGE 555 COURTHOUSE ROAD TOWN OF COBOURG


Landscape Englargments

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Tel. (519) 725-5140 FAX (519) 725-5144

DRAWN BY:	DESIGNED BY:	APPROVED BY:
BH/KLH	CMH/AWH	***
PROJECT NO.	SCALE:	DATE:
2018-36	1:500	July 2018
PLOTTED:	SHEET:	
August 12, 2019	L.	4

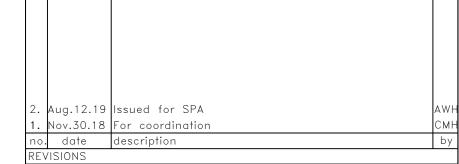

TRAFFIC CIRCLE

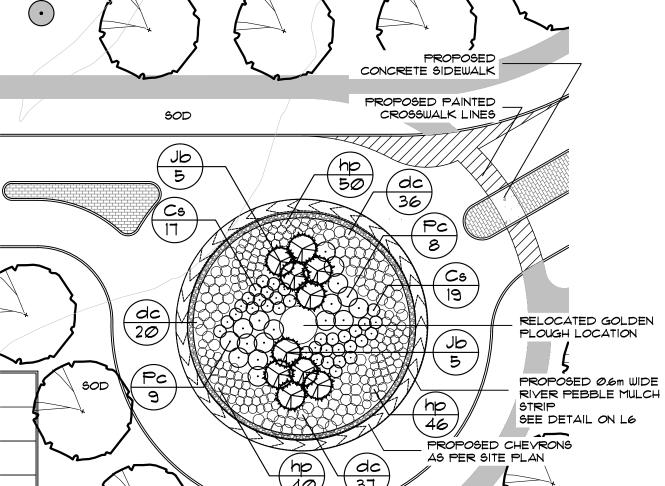PROPOSED PERMACON

MELVILLE PLANK
PAVER TRAFFIC
ISLANDS (TYP.) SEE


PROPOSED CONCRETE


PROPOSED BENCH BY VICTOR STANLEY (TYP.)

SEE DETAIL ON L6


PATIO AREA

- PROPOSED 1.8m WIDE ASPHALT PATHWAY SEE DETAIL ON L6

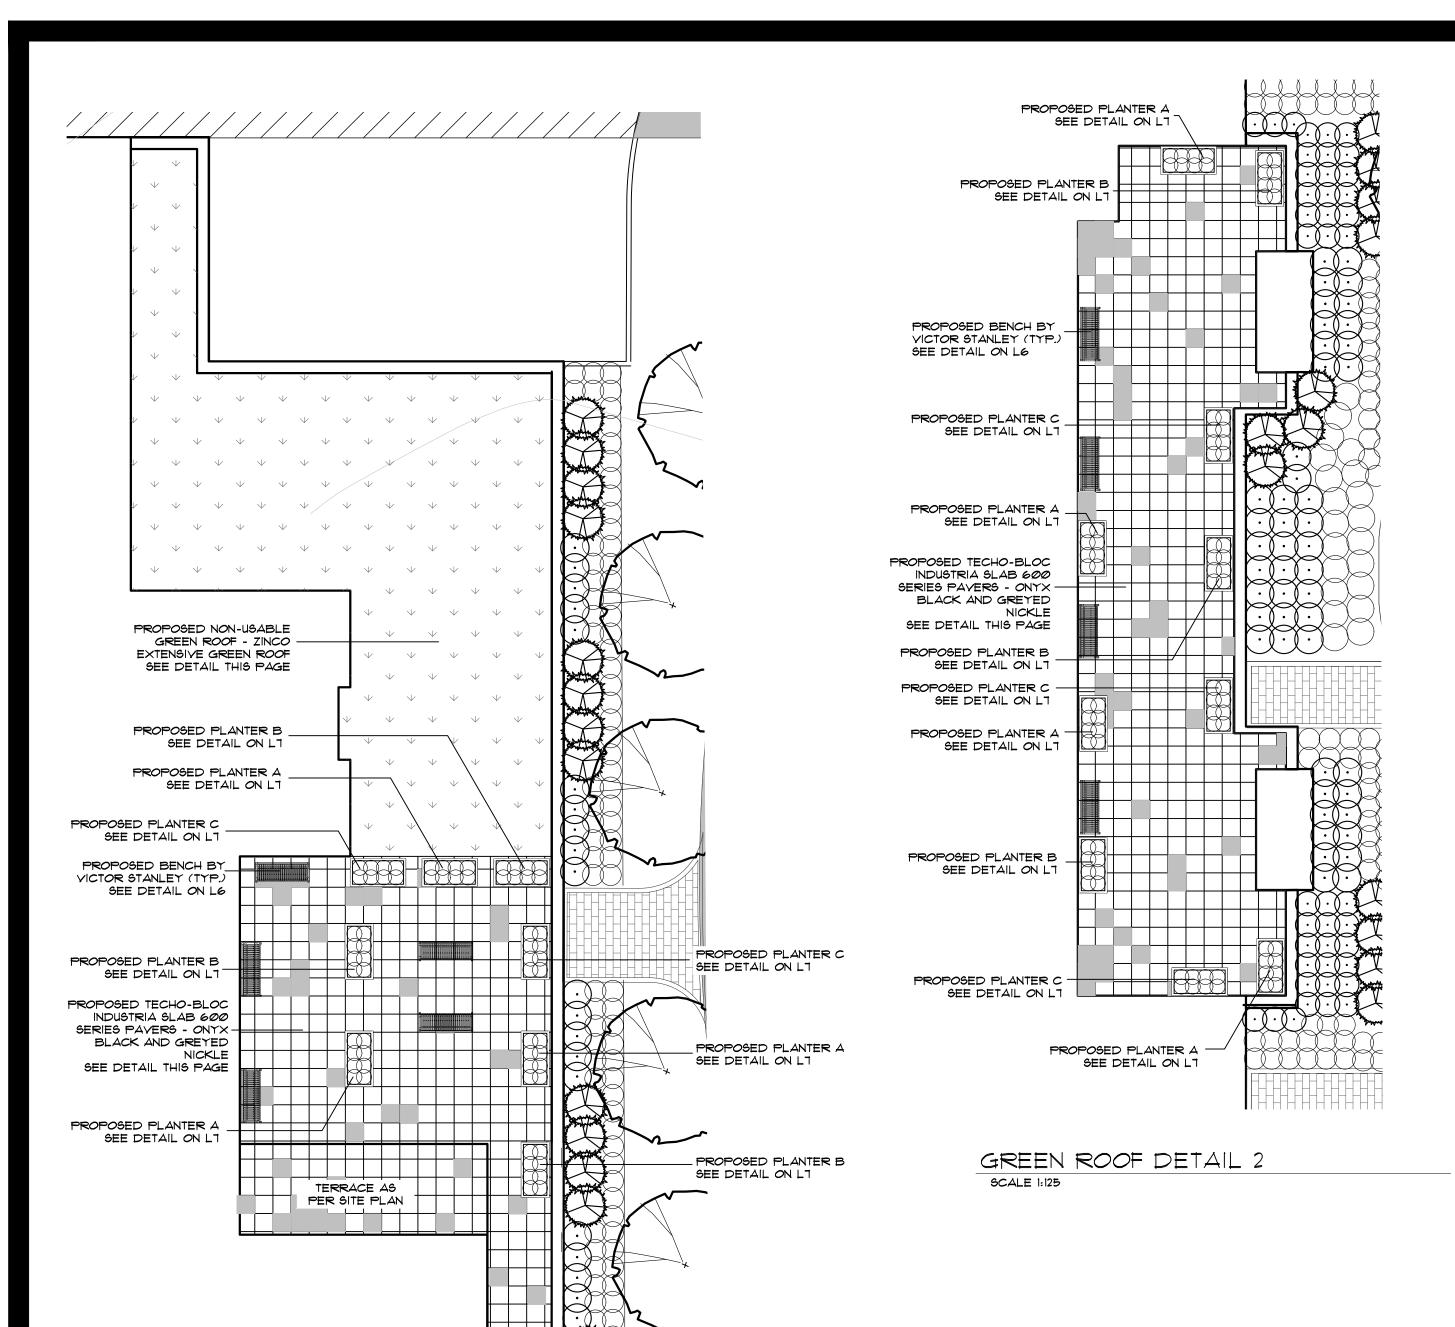

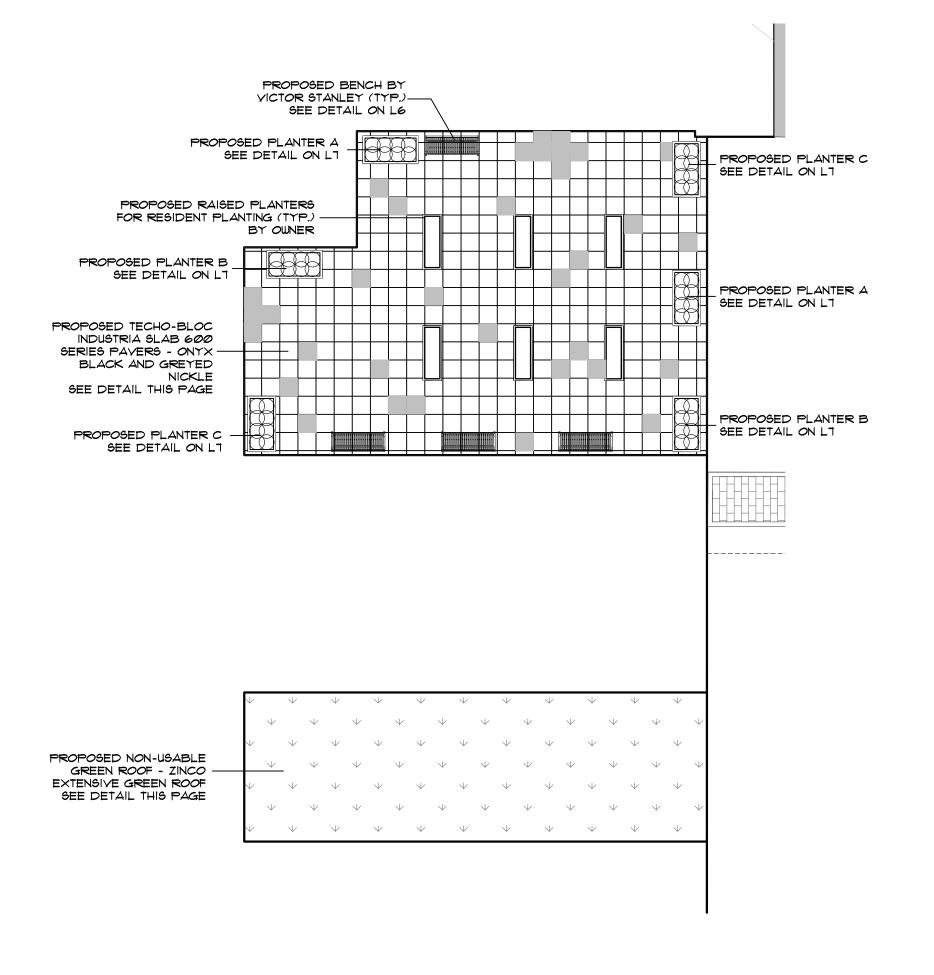

GREEN ROOF DETAIL 3

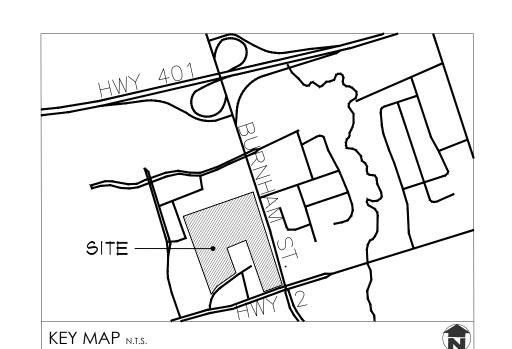

GENERAL NOTES

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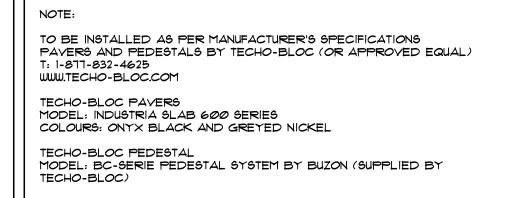
Aug.12.19 Issued for SPA

I. Nov.30.18 For coordination date description


MacKinnon &

Associates

Tel. (519) 725-5140




SCALE 1:125

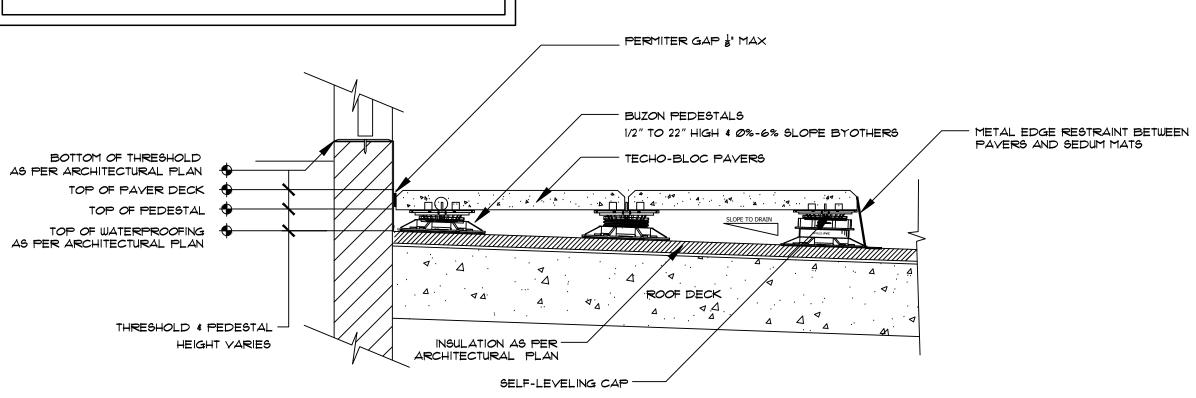

2

ROOF TOP UNIT PAVER DETAIL NTS

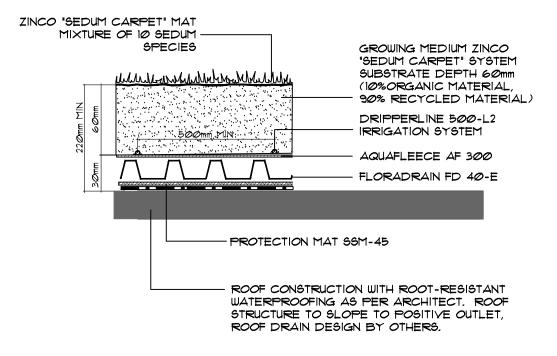

GREEN ROOF DETAIL

<u>NOTES</u>

EXTENSIVE GREEN ROOF COMPONENTS BY ZINCO CANADA INC. (905-690-1661) (greenroof@zinco.ca) OR APPROVED EQUIVALENT.

DRIPPERLINE 500-L2 IRRAGATION LINES TO BE CONNECTED TO ZINCO IRRAGATION UNIT B 32 OR APPROVED EQUIVALENT. POTABLE WATER CONNECTION TO DRIPPERLINE 500-L2 IRRIGATION SYSTEM BY ARCHITECT.

STRUCTURAL ENGINEER TO CONFIRM LOAD BEARING CAPACITY OF STRUCTURE BEFORE PLANTING.

ENSURE ALL ROOF PLANTING AREAS HAVE A POSITIVE DRAINAGE OUTLET (DESIGN AND LAYOUT BY OTHERS).

GREEN ROOF ELEMENTS ARE PROVIDED FOR REFERENCE PURPOSES ONLY - MANUFACTURER TO PROVIDE FINAL BUILD UP SHOP DRAWING FOR REVIEW.

ZINCO EXTENSIVE GREEN ROOF DETAIL

DRAWN BY:
BH/KLH
PROJECT NO.
2018-36
PLOTTED:
August 12, 2019
DESIGNED BY:
CMH/AWH
AWH
DATE:
July 2018

AUGUST 12, 2019
L5

550 Parkside Drive, Unit A-21, Waterloo, Ontario N2L 5V4

GOLDEN PLOUGH LODGE

555 COURTHOUSE ROAD


TOWN OF COBOURG


Green Roof Englargments & Details

oviding Solutions in Urban, 🏻 🌞

andscape and Environmental Planning

FAX (519) 725-5144

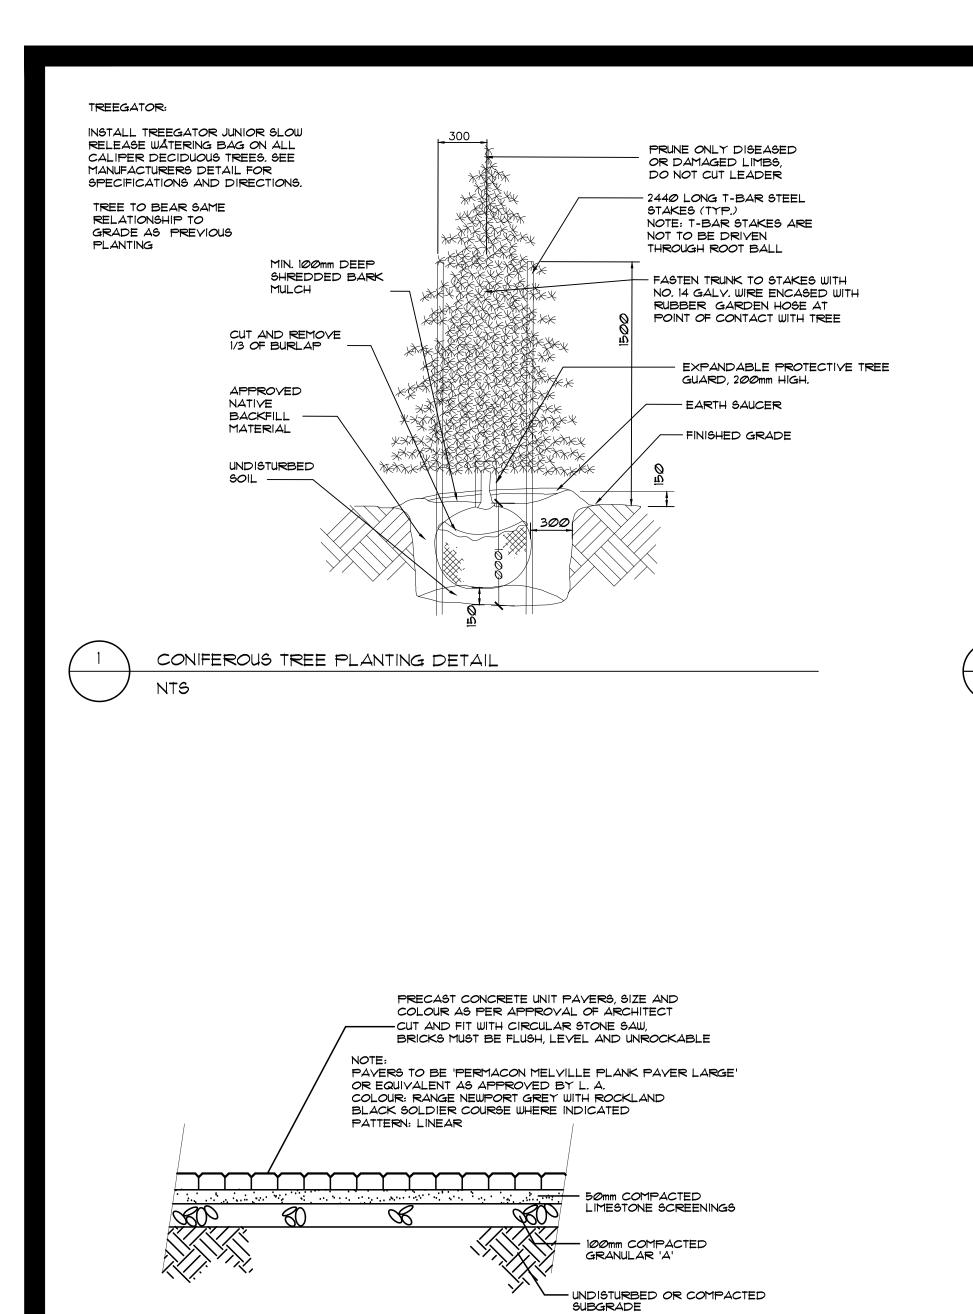

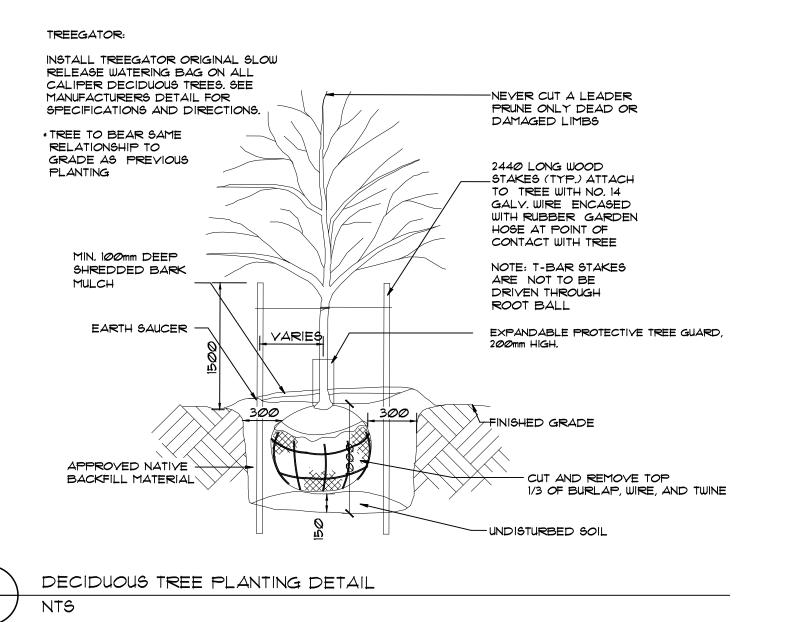

SURFACE TREATMENT VARIES REFER TO LAYOUT PLAN

ASPHALT MEETS SOFT LANDSCAPING. TO BE CUT FLUSH

150mm OF 19mm CRUSHER RUN LIMESTONE (PROFILE "A")

300mm OF 50mm CRUSHER RUN LIMESTONE (PROFILE "A"):

UNDISTURBED OR COMPACTED SUBGRADE TO 95% SPMDD

NOTE: ANY FILL REQUIRED TO RAISE GRADES TO BE PLACED IN 300mm LIFTS AND COMPACTED TO 95% SPMDD

TO BE CONFIRMED BY GEOTECHNICAL ENGINEER -

COMPACTED TO 100% SPMDD MIN 2% SLOPE

80mm ASPHALTIC CONCRETE: ASPHALTIC CONCRETE PAVING

HAND TAMP OUTER EDGE OF ASPHALT TO 45 WHERE

2% CROSS SLOPE TYPICAL. AS PER GRADING PLAN


WHERE ADJACENT TO CONCRETE.


MATERIALS TO CONFORM TO OPSS


40mm HL3 SURFACE


40mm HLS BINDER

COMPACTED TO 100% SPMDD

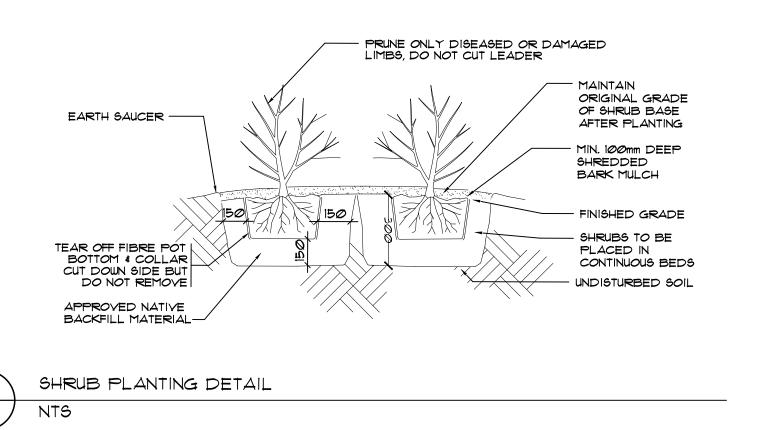

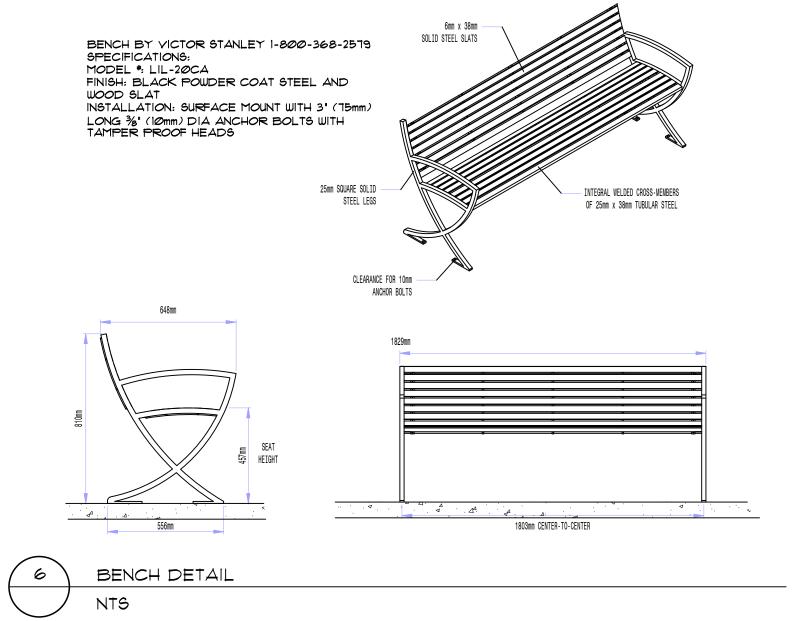


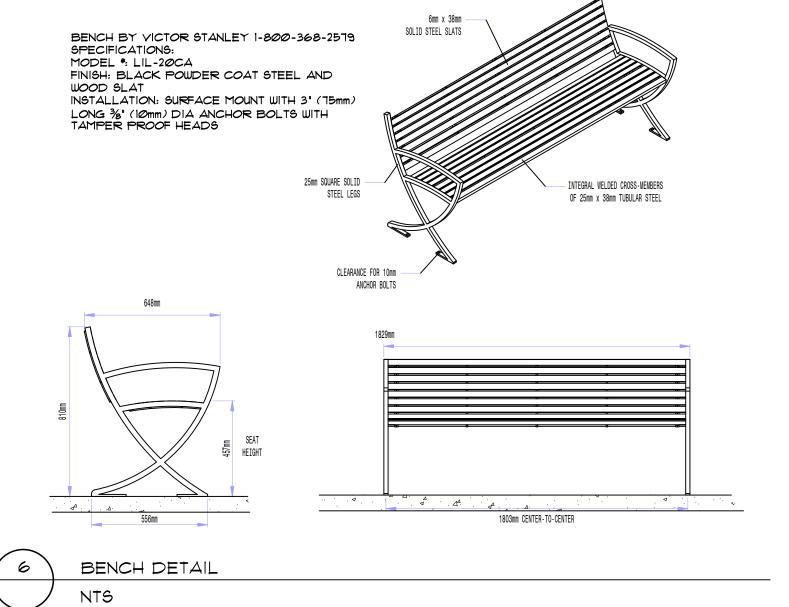

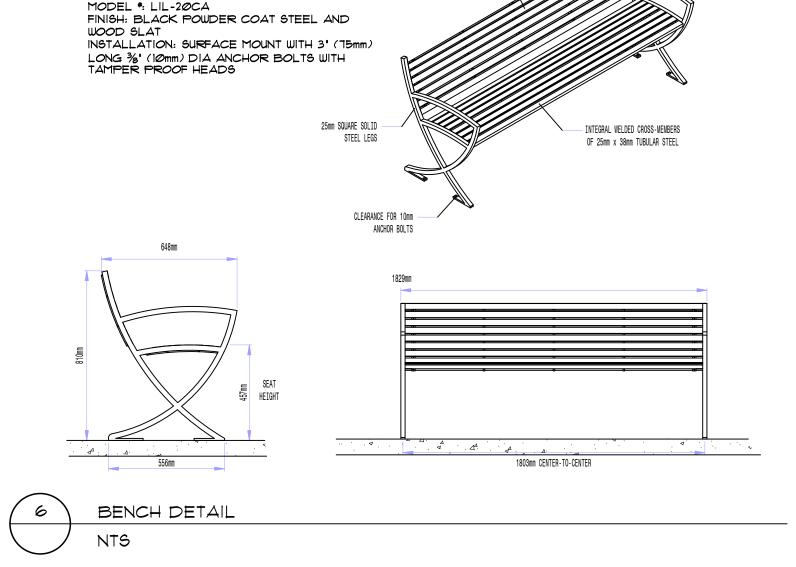

SHELTER BY RCP SHELTERS, LTD. (OR

16' GAZEBO DETAIL

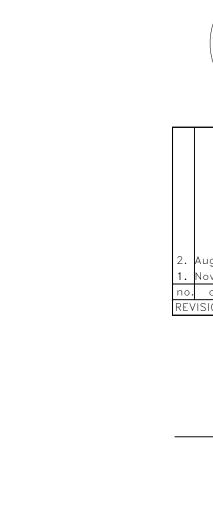

KEY MAP N.T.S.

ASSOCIATION.

GENERAL NOTES

OWNER'S ACCEPTANCE OF PROJECT.

ARCHITECT PRIOR TO INSTALLATION.

ALL TREE PITS AND PLANTING BEDS.

ADJACENT PROPERTIES, AS REQUIRED.

WORK INCLUDED IN THE CONTRACT.

STRUCTURES/SERVICES.

LANDSCAPE ARCHITECT.

1. ALL WORKMANSHIP WILL BE TO THE STANDARDS OF LANDSCAPE

ACCORDANCE WITH THE CANADIAN STANDARDS FOR NURSERY

STOCK, 6TH EDITION, 1998, BY THE CANADIAN NURSERY TRADES

GENERAL SOIL TYPE/CLASS NATIVE TO THE SITE. TOPSOIL TO BE TESTED FOR NUTRIENT VALUE, AND AMENDED FOR OPTIMAL GROWTH AS PER THE RECOMMENDATIONS OF THE SOIL TEST.

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6. PLANTING MAY BE ADJUSTED TO SUIT LOCATIONS OF SITE UTILITY

8. SPREAD MULCH TO A MINIMUM OF 100mm COMPACTED DEPTH ON

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PLANT LIST. ANY SUBSTITUTIONS SHALL BE APPROVED BY THE

AREAS TO MUNICIPAL SPECIFICATIONS AND REPAIR DAMAGE TO

COINCIDE WITH THE FINAL INSPECTION AND ACCEPTANCE OF ALL

10. SOD AS MARKED WITH NURSERY SOD ON A MINIMUM OF 100mm OF CLEAN TOPSOIL. FINE GRADE AND SOD ALL BOULEVARD

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CONTROL MATTING (COIR MAT, OR OTHER WILDLIFE FRIENDLY

ALTERNATIVE). PIN SOD ON ALL SLOPES OF 3:1 OR GREATER.

ACCEPTED DURING THE PERIOD OF JANUARY 1st TO JULY 15th

SHALL BE GUARANTEED UNTIL JULY 15th THE FOLLOWING YEAR.

DECEMBER 31st SHALL BE GUARANTEED FOR ONE YEAR FROM

THE DATE OF ACCEPTANCE. THE GUARANTEE PERIODS LISTED

13. SUBMIT A WRITTEN GUARANTEE TO THE EFFECT THAT ALL PLANTS

PLANTS ACCEPTED DURING THE PERIOD OF JULY 15th TO

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LEA CONSULTING LTD., DATED SEPTEMBER 10, 2018.

REPORTED IN WRITING TO THE LANDSCAPE ARCHITECT.

5. CONTRACTOR TO LOCATE ALL UNDERGROUND UTILITIES.

7. ALL MATERIALS MUST BE APPROVED BY LANDSCAPE




GOLDEN PLOUGH LODGE 555 COURTHOUSE ROAD TOWN OF COBOURG

Landscape Details



550 Parkside Drive, Unit A-21, Waterloo, Ontario N2L 5V4 Tel. (519) 725-5140 FAX (519) 725-5144

BH/KLH CMH/AWH PROJECT NO. 1:500 July 2018 2018-36 August 12, 2019

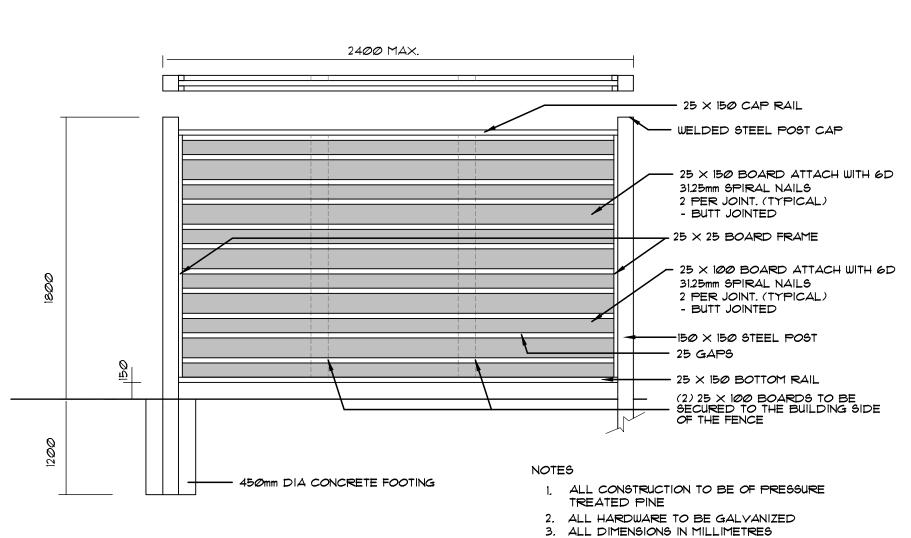

1.8m HIGH HORIZONTAL BOARD PRIVACY FENCE DETAIL

UNIT PAVER DETAIL

3. ALL DIMENSIONS IN MILLIMETRES 4. ALL PRESSURE TREATED CUTS TO BE DRESSED WITH COPPER NAPHANATE

Standard Heights 3', 3½', 4', 5', *6' 21" Min, Footing Depth ES:
 1.) Post size depends on fence height and wind loads.
 See MONTAGE²⁶ specifications for post sizing chart.
 2.) That all required for Double Rings.
 3.) Available in 3" sir space and/or Flush Bottom on most height.
 4.) Three rails required for 6' tall. E-COAT COATING SYSTEM Base Material -Iniform Zinc Coating — (Hot Dip) Epoxy Primer -AMERISTAR® 1555 N. Mingo Tulsa, OK. 74116 1-888-333-3422 DR: CI SH. 1of 1 SCALE: DO NOT SCALE

1. PRIOR TO CONSTRUCTION OF ASPHALT PATHWAYS, EXISTING SURFICIAL TOPSOIL TO BE REMOVED AND SUBGRADE PROOF-ROLLED AND

PROFILE

SLOPE /

EXCAVATION TO BE 300mm WIDER THAN FINISHED PATH WIDTH

ASPHALT PAVING DETAIL

NTS

3. DO NOT BACKFILL AGAINST ASPHALT MINIMUM 48 HOURS UNTIL

4. THIS DETAIL IS TO BE USED IN CONJUNCTION WITH SPECIFICATION

INSPECTED BY GEOTECHNICAL ENGINEER.

ALL DIMENSIONS SHOWN IN MILLIMETRES

ASPHALT HAS CURED


SECTION: ASPHALT PAVING

1.5m HIGH MONTAGE STEEL FENCE DETAIL


MONTAGE STEEL FENCE BY AMERISTAR (OR APPROVED EQUAL) T 1-888-333-3422 WWW.AMERISTARFENCE.COM SPECIFICATIONS: MODEL: MONTAGE CLASSIC FINISH: BLACK POWDER COAT OPTIONS: QUAD FLARE FINIAL INSTALLATION: AS PER MANUFACTURERS INSTRUCTIONS

MODEL: SLF-HEX20-04-M APPROVED EQUAL) T 800-825-0207 F 772-288-*0*2*0*7 MANUFACTURER TO PROVIDE STRUCTURAL AND FOOTING DESIGNS WWW.RCPSHELTERS.COM INFO@RCPSHELTERS.COM FINISHED GRADE CONCRETE FOOTING AS PER MANUFACTURER'S SPECIFICATIONS


SPECIFICATIONS:

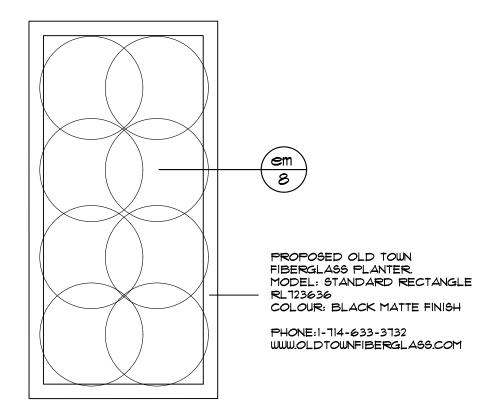



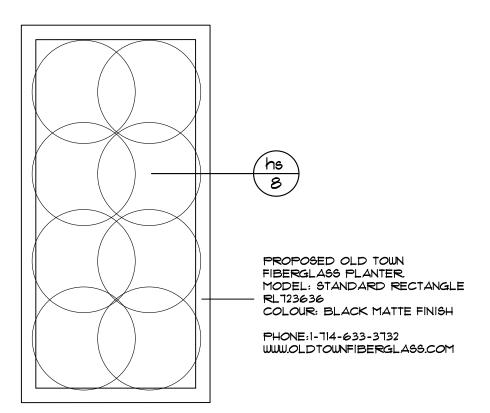



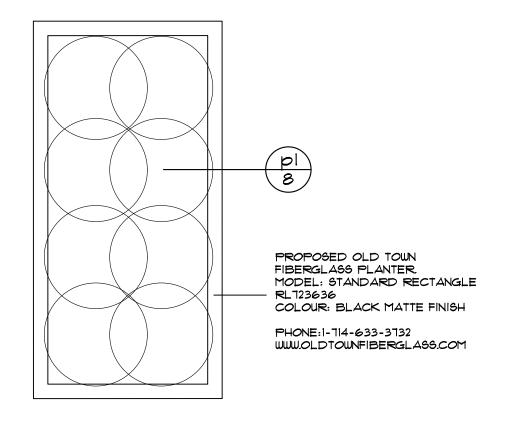




PLANTER C PLANTING DETAIL

NTS

PLANT MATERIAL LIST

KEY	QUANT.	BOTANICAL NAME	COMMON NAME	SIZE	COND.
Ą	3	Amelancheir canadensis	Serviceberry (Clump)	7⊘mm cal.	W.B.
AR	8	Acer rubrum 'Karpick'	Karpick Maple	7⊘mm cal.	W.B.
AS	25	Acer saccharum 'Bonfire'	Bonfire Sugar Maple	7⊘mm cal.	W.B.
CA		Carpinus caroliniana	Blue Beech	7⊘mm cal.	W.B.
CC	16	Cercis canadensis	Redbud (Clump)	7⊘mm cal.	W.B.
ر ک	19	Cercidiphyllum japonicum Red Fox	Red Fox Katsura	7⊘mm cal.	W.B.
CK	Ø	Cornus kousa Samaritan	Samaritan Dogwood (Treeform)	7⊘mm cal.	W.B.
0>	4	Ostrya virginiana	Ironwood	7⊘mm cal.	W.B.
ß	21	Picea glauca	White Spruce	250cm ht.	W.B.
PS	ī	Pinus strobus	White White Pine	250cm ht.	W.B.
Q	11	Quercus rubra	Red Oak	7⊘mm cal.	W.B.
TC	24	Tilia cordata Greenspire	Greenspire Linden	7⊘mm cal.	W.B.
Jb	10	Juniperus sabina 'Blue Danube'	Blue Danube Juniper	60cm, 3 gal.	Pot
Js	27	Juniperus sabina	Savin Juniper	60cm, 3 gal.	Pot
Cs	161	Cornus sanguinea 'Winter Beauty'	Winter Beauty Dogwood	60cm, 3 gal.	Pot
Dk	191	Diervilla x Kodiak Orange	Kodiak Orange Honeysuckle	60cm, 3 gal.	Pot
P	140	Physocarpus opulifolius 'Dart's Gold'	Dart Gold Ninebark	60cm, 3 gal.	Pot
PC	ΙΠ	Physocarpus opulifolis 'Centre Glow'	Centre Glow Ninebark	150cm ht.	W.B.
Sf	67	Spiraea japonica 'Froebelii'	Froebelii Spirea	150cm ht.	W.B.
Tc	14	Taxus cuspidata Emerald Spreader	Emerald Spreader Yew	150cm ht.	W.B.
Tm	45	Taxus x media 'Densiformis'	Dense Yew	150cm ht.	W.B.
d	226	Deschampsia cespitosa	Tufter Hair Grass	1 gal.	Pot
ра	99	Pennisetum alopecuroides 'Moudry'	Moudry Fountain Grass	1 gal.	Pot
hj	26	Hosta 'June'	June Hosta	1 gal.	Pot
ź	137	Hosta 'Yulcan'	Vulcan Hosta	1 gal.	Pot
þ	373	Hemerocallis 'Purple d'Oro'	Purple d'Oro Daylily	1 gal.	Pot
ń	254	Hemerocallis 'Stella d'Oro'	Stella d'Oro Daylily	1 gal.	Pot
d	114	Astilbe x 'Delft Lace'	Delft Lace Astilbe	1 gal.	Pot
em	231	Echinacea purpurea 'Meriot'	Merlot Coneflower	1 gal.	Pot
ls	104	Leucanthemum x superbum 'Becky'	Becky Daisy	1 gal.	Pot
rf	145	Rudbeckia fulgida 'Goldstrum'	Black Eyed Susan	1 gal.	Pot
ρ	235	Perovskia x 'Little Spire'	Little Spire Russian Sage	1 gal.	Pot
hm	134	Hakonechioa macra 'Aureola'	Variegated Japanese Forest Grass	1 gal.	Pot
lm	190	Liriope spicata 'Silver Dragon'	Silver Dragon Lily Turf	l gal.	Pot

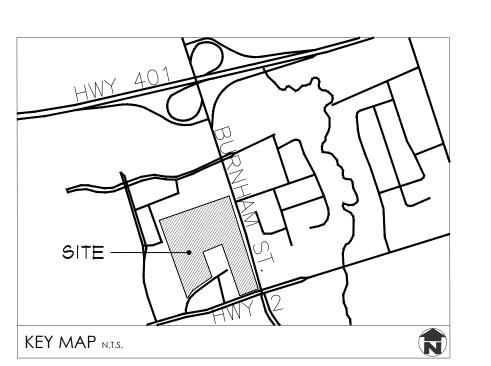


GENERAL NOTES

- ALL WORKMANSHIP WILL BE TO THE STANDARDS OF LANDSCAPE ONTARIO.
- ALL PLANT MATERIAL TO BE NO.1 GRADE NURSERY GROWN IN ACCORDANCE WITH THE CANADIAN STANDARDS FOR NURSERY STOCK, 6TH EDITION, 1998, BY THE CANADIAN NURSERY TRADES ASSOCIATION.
- 3. BACKFILL WILL CONSIST OF SOIL NATIVE TO THE SITE OR GENERAL SOIL TYPE/CLASS NATIVE TO THE SITE. TOPSOIL TO BE TESTED FOR NUTRIENT VALUE, AND AMENDED FOR OPTIMAL GROWTH AS PER THE RECOMMENDATIONS OF THE SOIL TEST.
- CONTRACTOR SHALL MAINTAIN ALL LANDSCAPE AREAS UNTIL OWNER'S ACCEPTANCE OF PROJECT.
- OWNER'S ACCEPTANCE OF PROJECT.

 5. CONTRACTOR TO LOCATE ALL UNDERGROUND UTILITIES.
- 6. PLANTING MAY BE ADJUSTED TO SUIT LOCATIONS OF SITE UTILITY STRUCTURES/SERVICES.
- ALL MATERIALS MUST BE APPROVED BY LANDSCAPE ARCHITECT PRIOR TO INSTALLATION.
- 8. SPREAD MULCH TO A MINIMUM OF 100mm COMPACTED DEPTH ON ALL TREE PITS AND PLANTING BEDS.
- 9. CHECK AND VERIFY ALL DIMENSIONS AND QUANTITIES PRIOR TO COMMENCEMENT OF WORK. ANY DISCREPANCIES ARE TO BE REPORTED IN WRITING TO THE LANDSCAPE ARCHITECT. QUANTITIES NOTED WITHIN THE PLAN SUPERCEDE THOSE IN THE PLANT LIST. ANY SUBSTITUTIONS SHALL BE APPROVED BY THE LANDSCAPE ARCHITECT.
- IØ. SOD AS MARKED WITH NURSERY SOD ON A MINIMUM OF IØØmm OF CLEAN TOPSOIL. FINE GRADE AND SOD ALL BOULEVARD AREAS TO MUNICIPAL SPECIFICATIONS AND REPAIR DAMAGE TO ADJACENT PROPERTIES, AS REQUIRED.
- 11. FINAL INSPECTION AND ACCEPTANCE OF PLANTING WORK SHALL COINCIDE WITH THE FINAL INSPECTION AND ACCEPTANCE OF ALL WORK INCLUDED IN THE CONTRACT.
- 12. ALL SEEDED SLOPES 3:1 AND GREATER TO RECEIVE EROSION CONTROL MATTING (COIR MAT, OR OTHER WILDLIFE FRIENDLY ALTERNATIVE). PIN SOD ON ALL SLOPES OF 3:1 OR GREATER.
- 13. SUBMIT A WRITTEN GUARANTEE TO THE EFFECT THAT ALL PLANTS ACCEPTED DURING THE PERIOD OF JANUARY 1st TO JULY 15th SHALL BE GUARANTEED UNTIL JULY 15th THE FOLLOWING YEAR. PLANTS ACCEPTED DURING THE PERIOD OF JULY 15th TO DECEMBER 31st SHALL BE GUARANTEED FOR ONE YEAR FROM THE DATE OF ACCEPTANCE. THE GUARANTEE PERIODS LISTED ABOVE SHALL APPLY TO ALL "NURSERY GROWN" PLANTS.
- 14. AT THE TIME OF FINAL INSPECTION ALL PLANTS SHALL BE IN A HEALTHY, VIGOUROUS GROWING CONDITION, PLANTED IN FULL ACCORDANCE WITH DRAWINGS AND CONDITIONS.
- 15. SITE PLAN INFORMATION AS PER SALTER PILON ARCHITECTS
- 16. TOPOGRAPHIC OR EXISTING CONDITIONS INFORMATION AS PER LEA CONSULTING LTD., DATED SEPTEMBER 10, 2018.



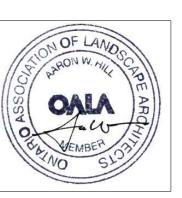

2. Aug.12.19 Issued for SPA
1. Nov.30.18 For coordination CMH
no. date description by
REVISIONS

GOLDEN PLOUGH LODGE 555 COURTHOUSE ROAD TOWN OF COBOURG

Landscape Details

MacKinnon & Associates

Providing Solutions in Urban, # Landscape and Environmental Planning

550 Parkside Drive, Unit A-21, Waterloo, Ontario N2L 5V4
Tel. (519) 725-5140 FAX (519) 725-5144

DRAWN BY:	DESIGNED BY	':	APPROVED BY:
BH/KLH		CMH/AWH	***
PROJECT NO.	SCALE:		DATE:
2018-36		1:500	July 2018
PLOTTED:	SHEET:		
August 12, 2019		1	7