


SANITARY SEWER DATA TABLE							
STRUCTURE No.	SIZE	RIM ELEV.	INVERT ELEVATIONS IN OUT		NOTES		
MH1A	1200mm	80.42	N 78.66 E 78.70	S 78.66	CONNECT TO EX. SEWER		
MH2A	1200mm	82.10	SE 79.11	W 79.05			
мнза	1200mm	82.19	SW 79.29 NE 79.29	NW 79.23			
MH4A	1200mm	82.44		NE 79.55			
MH5A	1200mm	82.48	NE 79.42	SW 79.38			
MH6A	1200mm	82.90	NE 79.61	SW 79.58			
MH7A	1200mm	83.46		SW 79.81			

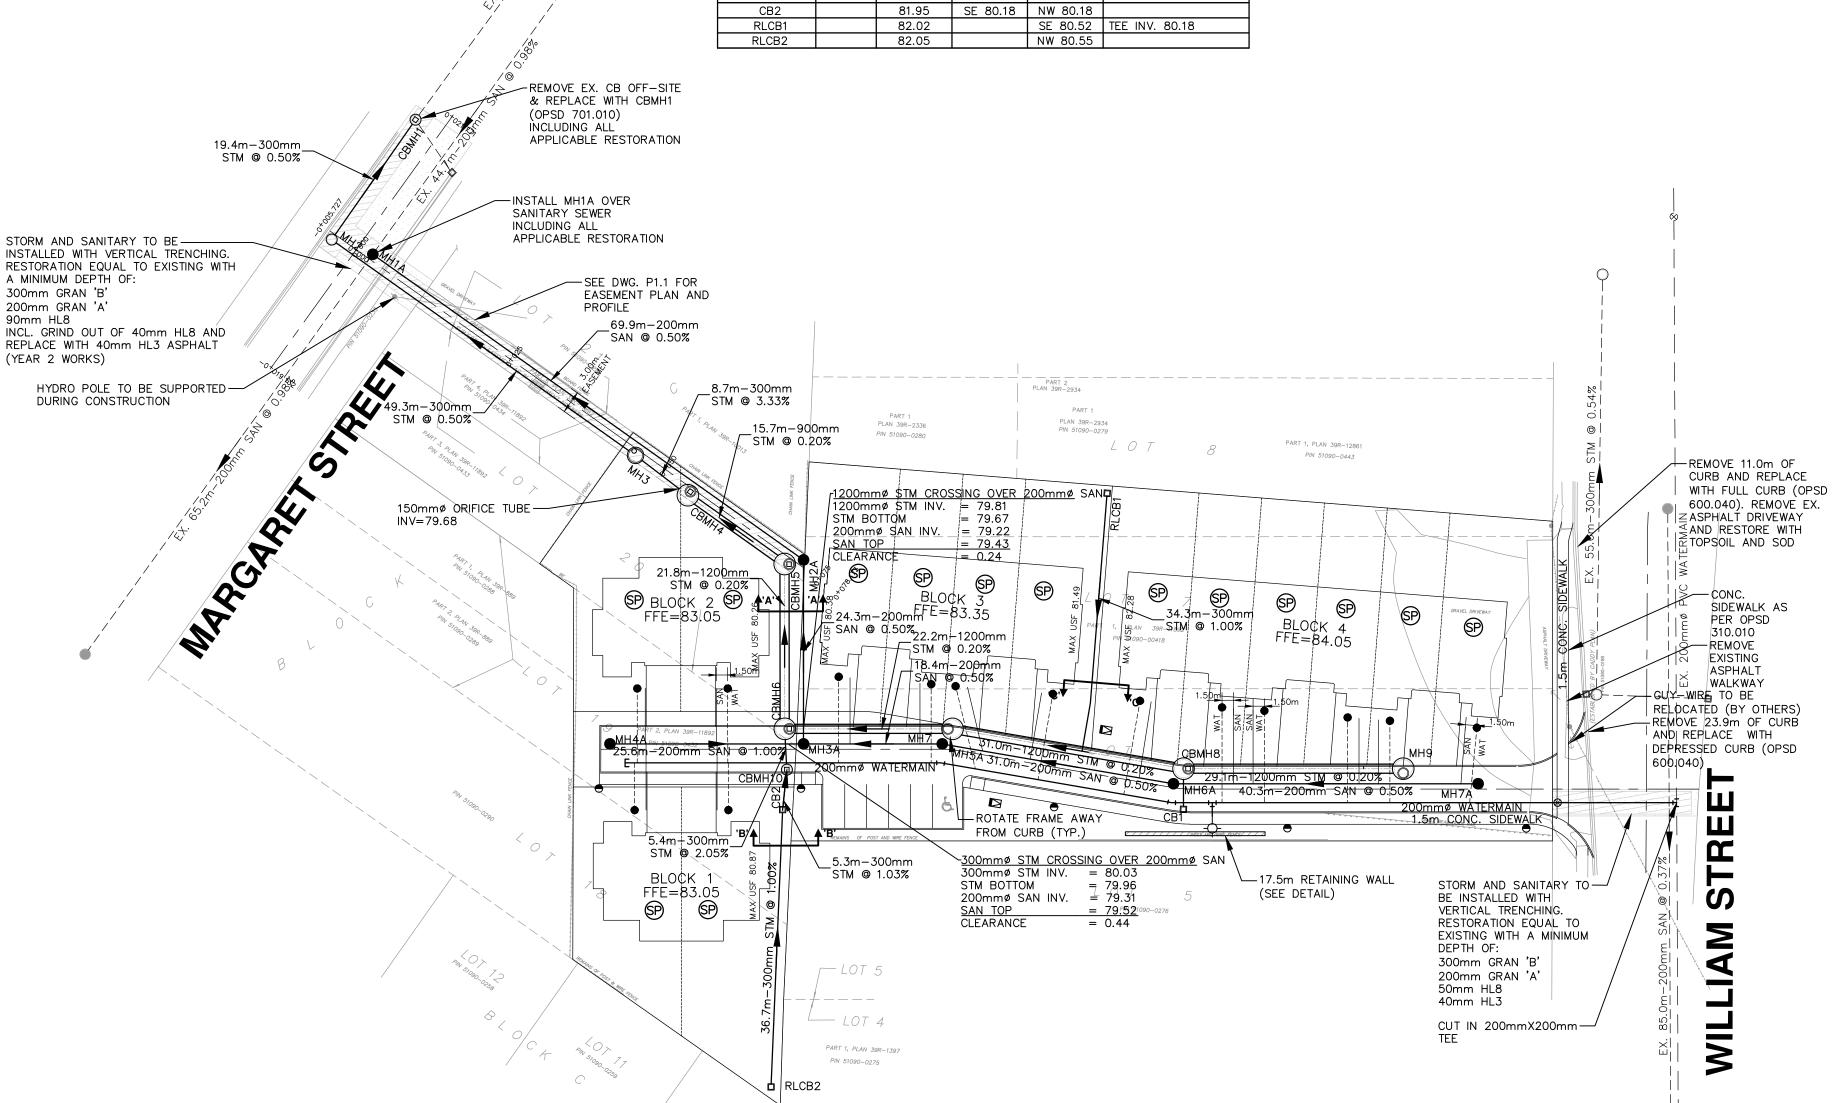

GENERAL NOTES

- MEASUREMENTS IN METRES AND/OR MILLIMETRES, UNLESS OTHERWISE SHOWN. ALL DIMENSIONS AND ELEVATIONS TO BE CHECKED AND VERIFIED ON SITE BY THE CONTRACTOR AND ANY DISCREPANCIES REPORTED PRIOR TO THE START OF WORK. 3. THE CONTRACTOR(S) SHALL BE SOLELY RESPONSIBLE FOR LOCATES, EXPOSING, SUPPORTING AND PROTECTING OF ALL UNDERGROUND AND OVERHEAD UTILITIES AND STRUCTURES EXISTING AT THE TIME OF CONSTRUCTION IN THE AREA OF THEIR WORK. WHETHER SHOWN ON THE PLANS OR NOT AND FOR ALL REPAIRS AND CONSEQUENCES
- RESULTING FROM DAMAGE TO SAME. 4. ALL TRENCHING TO BE DONE IN ACCORDANCE WITH THE CONSTRUCTION SAFETY ACT. 5. ALL INTERNAL WORK TO BE DONE IN ACCORDANCE WITH THE ONTARIO BUILDING CODE AND ONTARIO PROVINCIAL STANDARD SPECIFICATIONS AND DRAWINGS, UNLESS OTHERWISE
- 6. A ROAD OCCUPANCY PERMIT WILL BE REQUIRED FROM THE MUNICIPAL ROAD AUTHORITY FOR ALL WORKS WITHIN THE PUBLIC ROAD ALLOWANCE. THE CONTRACTOR IS RESPONSIBLE FOR ACQUIRING THE ROAD OCCUPANCY PERMIT(S), INCLUDING PROVIDING ALL REQUIRED
- REFER TO THE SITE PLAN FOR THE DIMENSIONING OF BUILDINGS, INTERIOR SIDEWALKS, DRIVEWAYS, PARKING AREAS AND CURBING.
- 8. THE CONTRACTOR SHALL PROVIDE TO THE ENGINEER ONE (1) SET OF AS-CONSTRUCTED SITE SERVICING, GRADING AND SITE ELECTRICAL DRAWINGS.

WATERMAINS AND FIREMAINS

SUPPORTING DOCUMENTATION.


- 1. ALL WATERMAINS AND FIREMAINS SHALL BE CONSTRUCTED IN ACCORDANCE WITH THE ONTARIO PROVINCIAL STANDARD SPECIFICATION OPSS 701 AND PART VII OF THE ONTARIO BUILDING CODE, UNLESS OTHERWISE SHOWN.
- WATERMAINS SHALL HAVE A MINIMUM VERTICAL CLEARANCE OF 0.50m OVER AND UNDER SEWERS AND ALL OTHER UTILITIES WHEN CROSSING. THE LENGTH OF WATER PIPE SHALL BE CENTRED AT THE POINT OF CROSSING SO THAT JOINTS WILL BE EQUIDISTANT AND AS FAR AWAY AS POSSIBLE FROM THE SEWER.
- 3. ALL WATERMAINS AND SERVICES SHALL HAVE 1.8m MINIMUM COVER AND HORIZONTAL SPACING OF 2.44m FROM ALL SEWER LINES. 100mm TO 300mm DIAMETER WATERMAINS AND FIREMAINS SHALL BE PVC SDR-18, C-900,
- CLASS 150 UNLESS OTHERWISE SHOWN. PIPE BEDDING AND BACKFILL FOR WATERMAINS SHALL BE AS PER OPSD 802.010 FOR FLEXIBLE PIPE UNLESS OTHERWISE SHOWN.
- ALL CURB STOPS TO BE 3.0m OFF THE FACE OF THE BUILDING UNLESS OTHERWISE NOTED. ALL PROPOSED WATER PIPING MUST BE ISOLATED FROM EXISTING LINES IN ORDER TO ALLOW INDEPENDENT PRESSURE TESTING AND CHLORINATING FROM EXISTING SYSTEMS PRIOR TO CONNECTION, USING TEST POINT BY-PASS AS REQUIRED.
- EITHER CONCRETE THRUST BLOCKS AS PER OPSD 1103.010 AND 1103.020 OR MECHANICALLY RESTRAINED JOINTS SHALL BE USED. MECHANICAL JOINT RESTRAINT SHALL
- BE UNI-FLANGE SERIES 1350 OR APPROVED. PROVISIONS FOR FLUSHING WATERMAINS MUST BE PROVIDED WITH AT LEAST A 50mm OUTLET ON 100mm AND LARGER LINES. COPPER LINES ARE TO HAVE FLUSHING POINTS AT THE END, THE SAME SIZE AS THE LINE. FIREMAINS FLUSHING OUTLET TO BE 100mm DIAMETER MINIMUM OR A HYDRANT. FLUSHING POINTS MUST BE HOSED OR PIPED TO
- ALLOW THE WATER TO DRAIN 10. FIRE HYDRANTS SHALL CONFORM TO AWWA C502 OR LATEST REVISION AND BE PROVIDED WITH A STORZ PUMPER CONNECTION. HYDRANTS SHALL BE INSTALLED IN ACCORDANCE WITH OPSD 1105.010. HYDRANT FLANGE ELEVATIONS TO BE INSTALLED 0.15m ABOVE THE PROPOSED FINISHED GRADE AT HYDRANT
- 11. TRACER WIRE SHALL BE ATTACHED TO EVERY NON-METALLIC WATERMAIN, FIREMAIN AND SERVICE CONNECTION. 12. ALL WATERMAIN STUBS SHALL BE TERMINATED WITH A PLUG AND 50mm BLOW-OFF
- UNLESS OTHERWISE NOTED. 13. ALL NEW WATERMAINS AND SERVICES TO BE PRESSURE TESTED TO 1379kPa (200 psi) FOR AT LEAST ONE (1) HOUR WITHOUT LEAKAGE.
- 14. THE CONTRACTOR SHALL SUCCESSFULLY SWAB AND CHLORINATE WATERMAINS AND SERVICES PRIOR TO CONNECTING TO EXTERNAL WATERMAINS. CONNECTION TO MUNICIPAL WATERMAIN SHALL NOT BE GRANTED UNTIL A POSITIVE LABORATORY TEST RESULT IS PROVIDED AND ACCEPTED
- 15. ALL HYDRANTS ON PRIVATE PROPERTY TO BE PAINTED RED AND THE STORZ PAINTED
- 16. PRIVATE WATER SUPPLY LINES HAVE BEEN DESIGNED IN ACCORDANCE WITH M.O.E.C.C. GUIDELINES AS PER 7.1.6.5 OF THE O.B.C.
- 17. UNLESS OTHERWISE NOTED ALL WATERMAIN CROSSINGS ARE TO BE ACCOMMODATED USING VERTICAL PIPE DEFLECTIONS.
- 18. ALL TRENCHES ARE TO BE BACKFILLED TO THE STANDARD PROCTOR DENSITY AS SPECIFIED BY THE GEOTECHNICAL CONSULTANT. 19. BUILDING SERVICE VALVES TO BE 3.0m OFF THE FACE OF THE BUILDING UNLESS
- OTHERWISE NOTED AND MUST BE RESTRAINED A MINIMUM OF 12.0m BACK FROM STUB.

STORM AND SANITARY SEWERS

- 1. ALL STORM AND SANITARY SEWERS SHALL BE CONSTRUCTED IN ACCORDANCE WITH THE ONTARIO PROVINCIAL STANDARD SPECIFICATION OPSS 410 AND PART VII OF THE ONTARIO BUILDING CODE, UNLESS OTHERWISE SHOWN.
- SANITARY SEWER PIPES 375mm AND SMALLER SHALL BE PVC SDR-35 CONFORMING TO CSA B182.2 AND B182.4, UNLESS OTHERWISE NOTED. PIPES SHALL BE JOINTED BY MEANS
- OF APPROVED RUBBER GASKETS. STORM SEWER PIPES 375mm AND SMALLER SHALL BE RIBBED PVC CONFORMING TO CSA B182.2 AND B182.4, UNLESS OTHERWISE NOTED. PIPES SHALL BE JOINTED BY MEANS OF APPROVED RUBBER GASKETS.
- STORM SEWER PIPES 450mm AND LARGER SHALL BE STEEL REINFORCED CONCRETE PIPE CLASS 65-D, CONFORMING TO SPECIFICATION CSA A257.1, A257.3, UNLESS OTHERWISE NOTED PIPES SHALL BE JOINTED BY MEANS OF APPROVED RUBBER GASKETS.
- PIPE BEDDING AND BACKFILL SHALL BE AS PER OPSD 802.010 FOR FLEXIBLE PIPE AND OPSD 802.030 AND 802.031 FOR RIGID PIPE, UNLESS OTHERWISE SHOWN. MANHOLES SHALL BE AS PER OPSD 701.010, 701.011, 701.012, 701.013, 701.014 AND
- 701.015. FRAMES AND COVERS AS PER OPSD 401.010. DROP STRUCTURES AS PER OPSD 1003.01. MANHOLES SHALL BE 1200mm IN DIAMETER, UNLESS OTHERWISE SHOWN. 7. SINGLE CATCHBASINS SHALL BE AS PER OPSD 705.010, DOUBLE CATCHBASINS SHALL BE AS PER OPSD 705.020. FRAMES AND COVERS AS PER OPSD 400.010 WHEN ADJACENT TO CURBS AND OPSD 400.020 IN OTHER AREAS. CATCHBASIN LEADS SHALL BE 200mm AT
- MINIMUM 1.0% GRADE, UNLESS OTHERWISE NOTED. 8. STORM AND SANITARY SEWERS AND APPURTENANCES WITHIN A PUBLIC ROAD ALLOWANCE SHALL BE CONSTRUCTED IN ACCORDANCE WITH LOCAL MUNICIPAL AUTHORITY STANDARDS. THE CONTRACTOR SHALL SUBMIT A VIDEO INSPECTION REPORT OF ALL INSTALLED STORM AND SANITARY MAINS, INCLUDING CATCHBASIN LEADS AND SERVICES PRIOR TO
- ACCEPTANCE. 10. SERVICE CONNECTIONS SHALL TERMINATE 1.5m FROM THE FACE OF THE BUILDING, UNLESS
- 11. ALL DOWNSPOUTS SHALL BE DISCONNECTED AND DISCHARGE DIRECTLY TO THE SURFACE
- 12. MINIMUM DEPTH OF COVER OF 1.4m FOR STORM SEWERS AND 1.8m FOR SANITARY SEWERS, UNLESS OTHERWISE SHOWN.


13. PRIVATE SEWERS HAVE BEEN DESIGNED IN ACCORDANCE WITH M.O.E.C.C. GUIDELINES AS

- PER 7.1.6.5 OF THE O.B.C. 14. MINIMUM PIPE CROSSING CLEARANCE FOR STORM AND SANITARY SEWERS IS TO BE 0.15m.
- 15. SANITARY SERVICE CONNECTIONS MUST BE INSTALLED USING WYE CONNECTIONS.

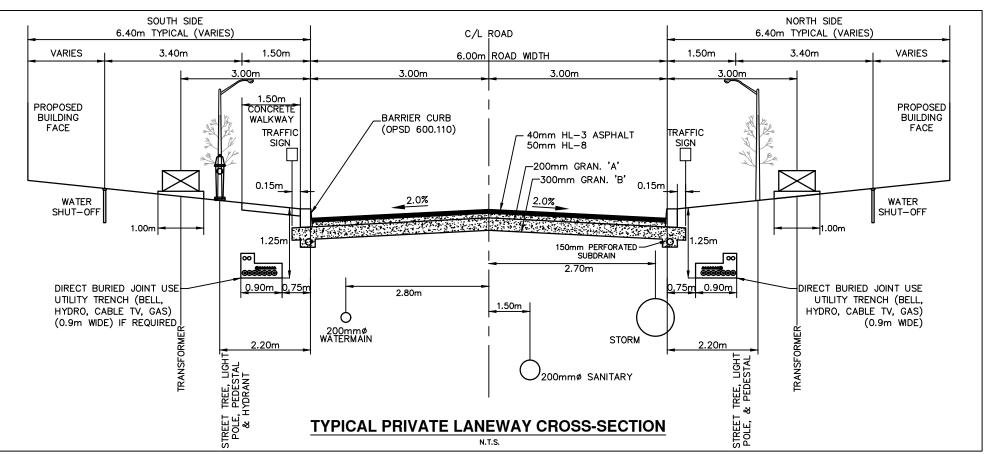



LEGEND

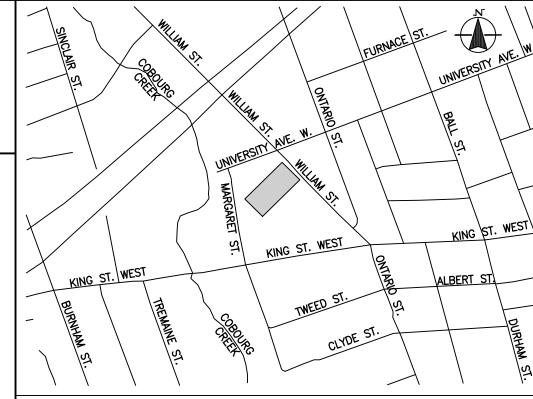

KEY PLAN

	SANITARY MANHOLE
0	STORM MANHOLE
	CATCHBASIN MANHOLE
	DOUBLE CATCHBASIN MANHO
	CATCHBASIN
	DOUBLE CATCHBASIN
ф	FIRE HYDRANT & VALVE BOX
1	

WATER VALVE & BOX STREET LIGHT TRANSFORMER BELL PLANT lacktriangledown

ROGERS PLANT LIMIT OF DEVELOPMENT LIMIT OF CONSTRUCTION

FF=100.00 FINISHED FLOOR ELEVATION PROPOSED 125mmø DOUBLE SANITARY CONNECTION WITH

100mmø WYES PROPOSED 125mmø (SINGLE) SANITARY CONNECTION PROPOSED 150mmø DOUBLE

125mmø WYES PROPOSED 150mmø (SINGLE) __-_-STORM CONNECTION

STORM CONNECTION WITH

--● PROPOSED 25mmø WATER SERVICE CONNECTION VERTICAL TRENCHING. FULL DEPTH PERMANENT ROAD

RESTORATION RESTORE WITH: 90mm HL8 ASPHALT 200mm GRAN 'A'

300mm GRAN 'B' INCL. GRIND OUT OF 40mm HL8 AND REPLACE WITH 40mm HL3 ASPHALT (YEAR 2 WORKS)

EXTENT OF REQUIRED PAVEMENT AND/OR BOULEVARD RESTORATION. FULL WIDTH, HL8 TO SURFACE & SURFACE PAVEMENT JOINT TREATMENT. RESTORATION DURING YEAR

. GRIND OUT OF 40mm HL8 AND REPLACE WITH 40mm

SUMP PUMP REQUIRED

LEGAL DESCRIPTION:

LOTS 6, 7, & PART OF LOT 8-BLOCK B LOT 20 & PART OF LOTS 18, 19, & 21-BLOCK C CADDY PLAN

TOWN OF COBOURG COUNTY OF NORTHUMBERLAND

REFERENCE DRAWINGS:

FOR SITE PLAN INFORMATION REFER TO DRAWING A1.00, DATED OCTOBER 2014, PROJECT No. 14020 BY PEARCE McCLUSKEY ARCHITECTS.

SURVEY INFORMATION:

SURVEY INFORMATION TAKEN FROM DRAWING No. 0 16, FILE No. 4-5003-TOPOBASE_V2, PREPARED BY IVAN B. WALLACE O.L.S. LTD. DATED 23rd. DAY OF AUGUST 2018.

BENCHMARK INFO:

ELEVATIONS ARE REFERRED TO THE TOWN OF COBOURG BENCHMARK No. 9, HAVING AN ELEVATION OF 80.475m.


REVISIONS						
No.	BY	DATE	DESCRIPTION	APPROVED		
1	A.W.	11.20.19	FIRST SPA SUBMISSION			
				•		

TOWN OF COBOURG ENGINEERING AND ENVIRONMENTAL SERVICES

377 WILLIAM STREET

SITE SERVICING PLAN



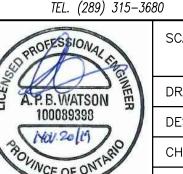

)	FAX (905) 794-	0611
SCALE : 1:500)	PROJECT No.
		E19012
DRAWN BY:	K.D.	
DESIGNED BY:	K.D.	DRAWING No.
CHECKED BY :	A.W.	SS

