


- AND THE REQUIREMENTS OF THE TOWN OF COBOURG AND THE REGIONAL MUNICIPALITY OF HALTON; WHICH CODES AND REGULATIONS SHALL SUPERSEDE ALL OTHERS.
- DETERMINE DEGREE OF INSPECTION AND TESTING REQUIRED FOR CERTIFICATION OF UNDERGROUND SERVICES INSTALLATION AS MANDATED BY ONTARIO BUILDING CODE, VISION C, PART 1 SECTION 1.2.2, GENERAL REVIEW. FAILURE TO NOTIFY ENGINEER WILL RESULT IN EXTENSIVE POST CONSTRUCTION INSPECTION AT CONTRACTOR'S EXPENSE.
- STANDARDS OF THE LOCAL MUNICIPALITY AND THE MTO MANUAL OF UNIFORM TRAFFIC CONTROL DEVICES
- SHOWN ON THE CONTRACT DRAWINGS, AND WHERE SHOWN, THE ACCURACY OF THE POSITION OF SUCH UTILITIES AND STRUCTURES IS NOT GUARANTEED. BEFORE STARTING WORK, THE CONTRACTOR SHALL INFORM HIMSELF OF THE EXACT LOCATION OF ALL SUCH UTILITIES AND

- ASPHALT AREA IS TO BE INSPECTED BY THE GEOTECHNICAL ENGINEER PRIOR TO PLACING GRANULAR. MINIMUM PAVEMENT REQUIREMENTS ARE AS FOLLOWS. (PER TIL TORONTO INSPECTION LTD., GEOTECHNICAL REPORT, REF No. 5434W-20-GA, DATED JANUARY 4, 2021) LIGHT DUTY ASPHALT(PARKING) 65mm HL3 SURFACE ASPHALT COMPACTION REQUIREMENTS(MINIMUM) 96% MAX. RELATIVE DENSITY (OPSS HL3 or EQUIVALENT) (OPSS HL3 or EQUIVALENT)

100% SPMDD* 100% SPMDD*

HEAVY DUTY ASPHALT 40mm HL3 SURFACE ASPHALT 50mm HL8 BASE ASPHALT (OPSS HL8 or EQUIVALENT) 150mm OPSS GRANULAR OR 20mm CRUSHER RUN 300mm OPSS GRANULAR E OR 50mm CRUSHER RUN

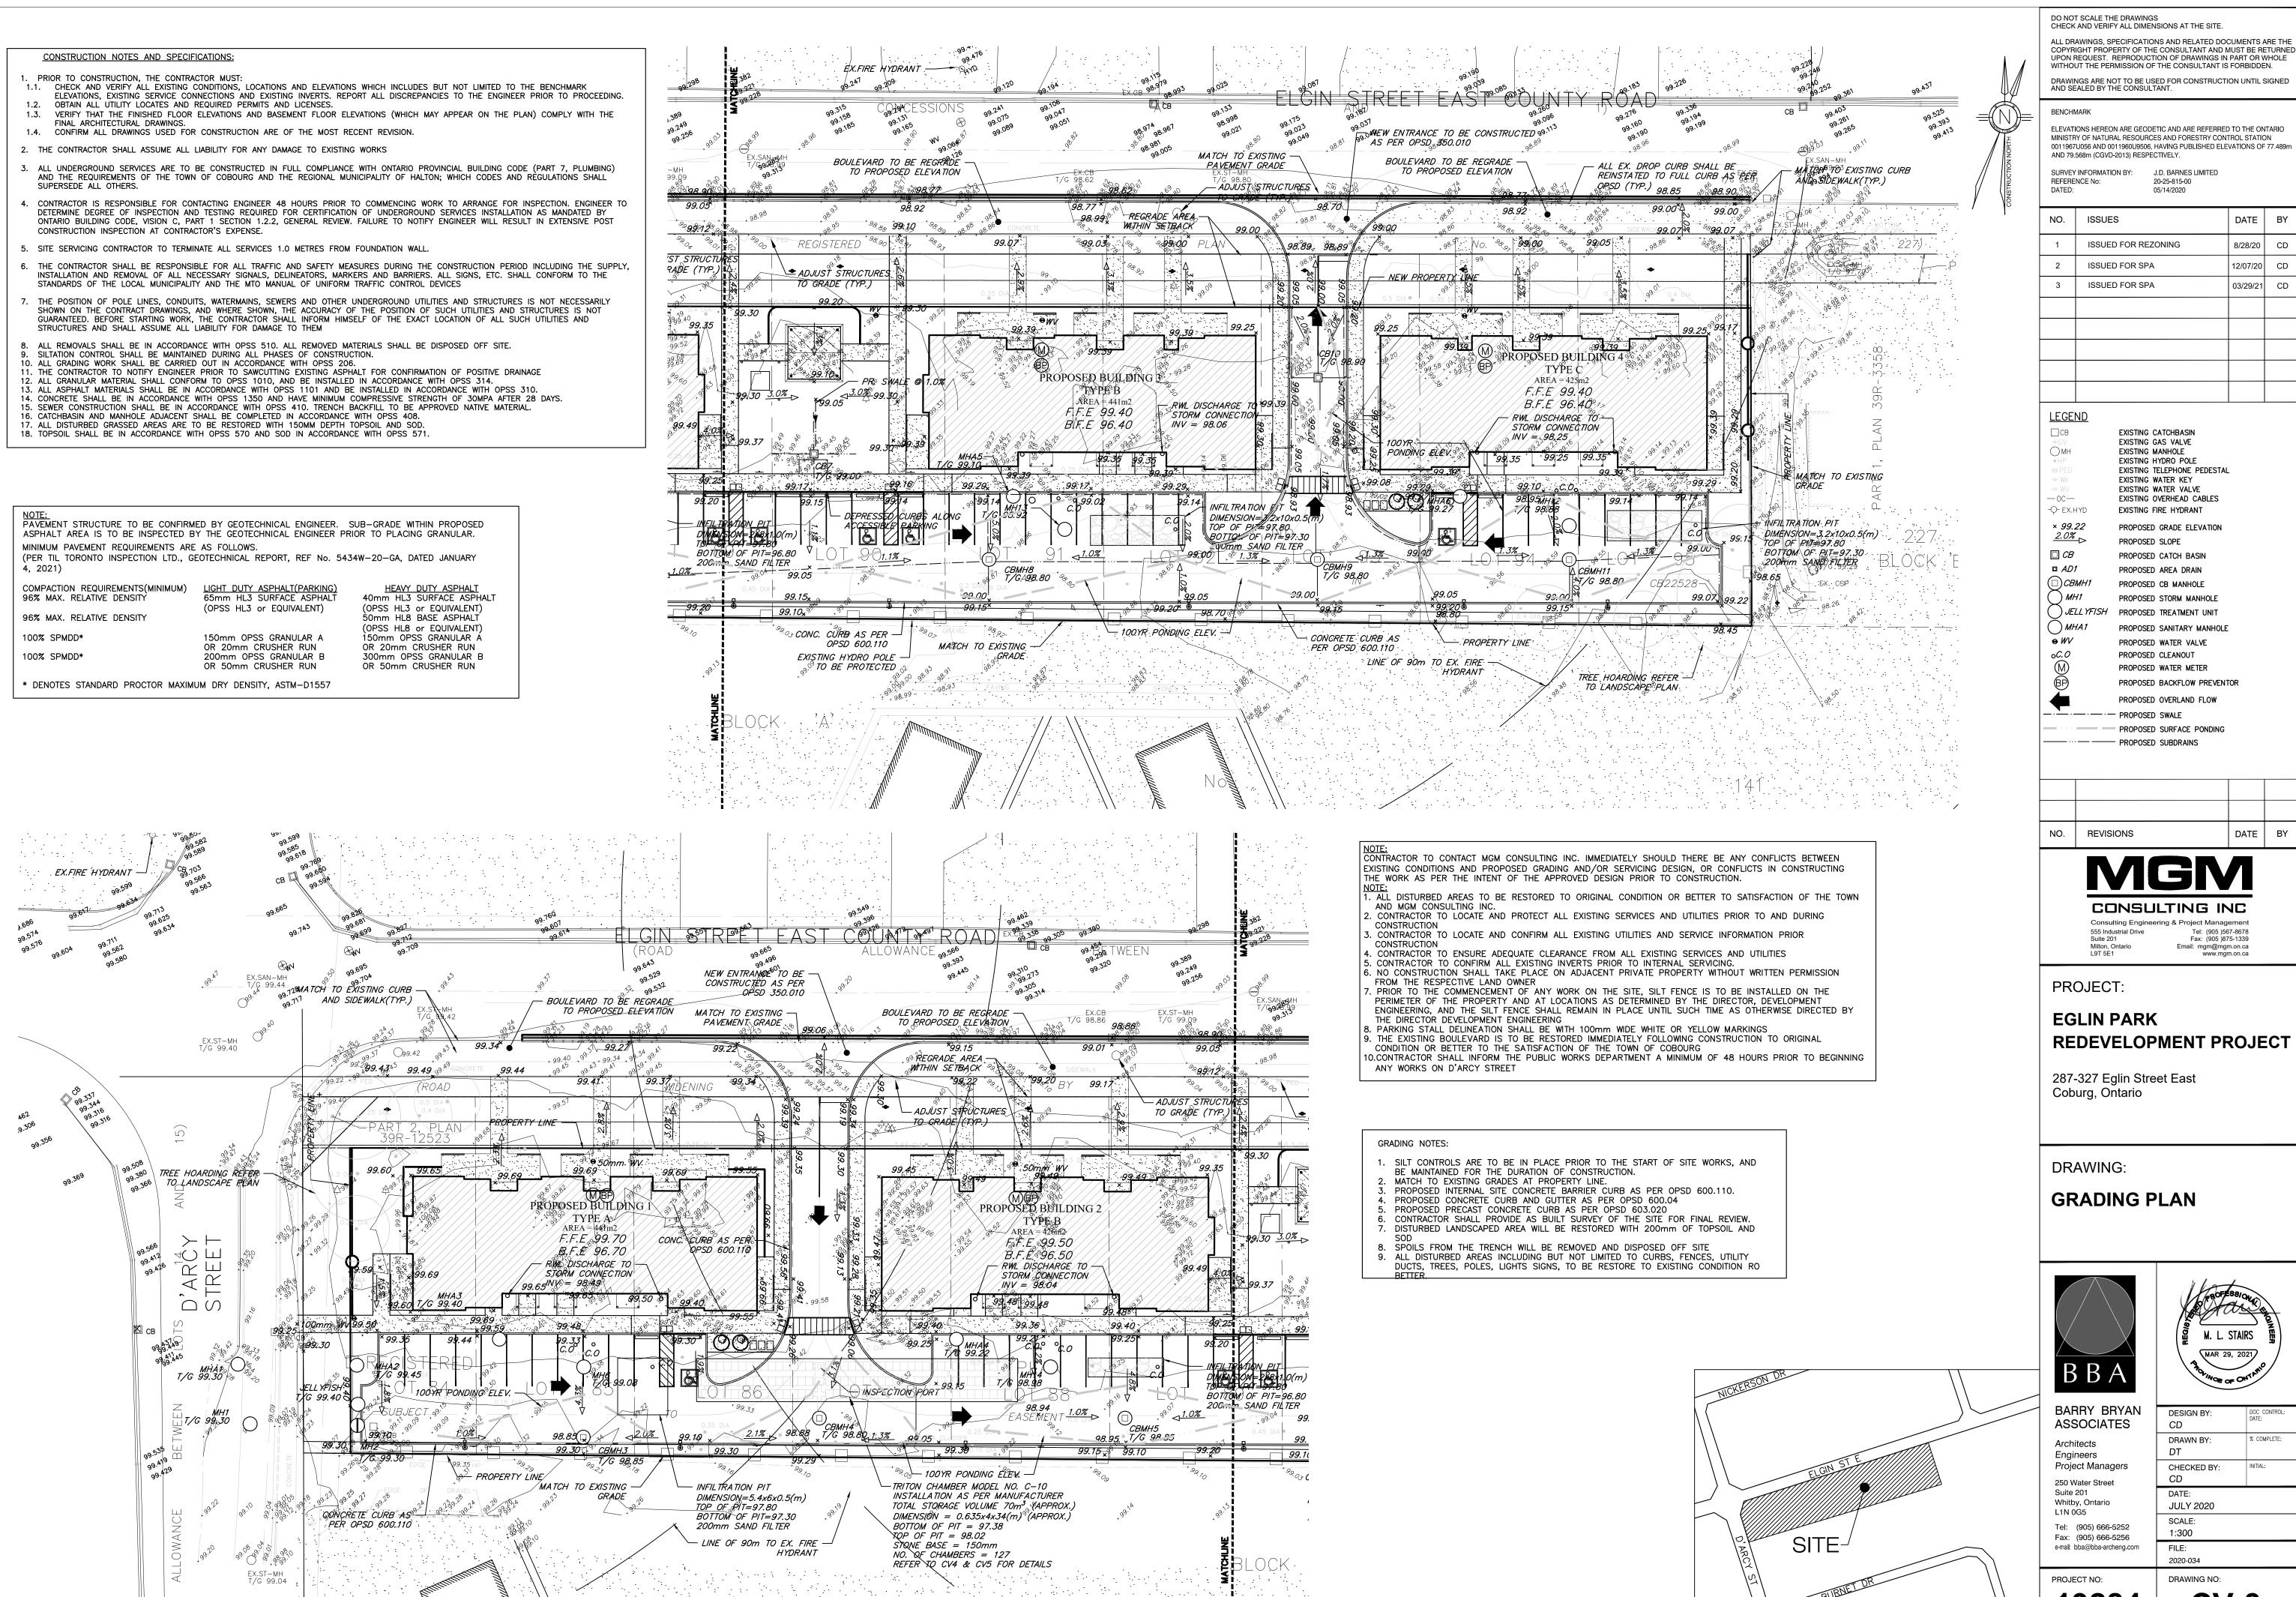

DRAWINGS ARE NOT TO BE USED FOR CONSTRUCTION UNTIL SIGNED AND SEALED BY THE CONSULTANT. BENCHMARK ELEVATIONS HEREON ARE GEODETIC AND ARE REFERRED TO THE ONTARIO MINISTRY OF NATURAL RESOURCES AND FORESTRY CONTROL STATION 0011967U056 AND 0011960U9506, HAVING PUBLISHED ELEVATIONS OF 77.489m AND 79.568m (CGVD-2013) RESPECTIVELY. SURVEY INFORMATION BY: J.D. BARNES LIMITED REFERENCE No: 20-25-815-00 05/14/2020 DATE BY ISSUES 8/28/20 CD ISSUED FOR REZONING ISSUED FOR SPA 12/07/20 CD ISSUED FOR SPA 03/29/21 CD <u>LEGEND</u> EXISTING CATCHBASIN EXISTING GAS VALVE EXISTING MANHOLE EXISTING HYDRO POLE EXISTING TELEPHONE PEDESTAL EXISTING WATER KEY EXISTING WATER VALVE EXISTING OVERHEAD CABLES -Q- EX.HYD EXISTING FIRE HYDRANT × 99.22 PROPOSED GRADE ELEVATION <u>2.0%</u> PROPOSED SLOPE PROPOSED CATCH BASIN PROPOSED AREA DRAIN 🗆 СВМН1 PROPOSED CB MANHOLE) MH1 PROPOSED STORM MANHOLE) JELL YFISH PROPOSED TREATMENT UNIT) MHA1 PROPOSED SANITARY MANHOLE PROPOSED WATER VALVE PROPOSED CLEANOUT PROPOSED WATER METER PROPOSED BACKFLOW PREVENTOR PROPOSED OVERLAND FLOW · · · · · · · PROPOSED SWALE PROPOSED SURFACE PONDING DATE ΒY REVISIONS GN CONSULTING INC Consulting Engineering & Project Management 555 Industrial Drive Suite 201 Tel: (905)567-8678 Fax: (905)875-1339 Milton, Ontario L9T 5E1 Email: mgm@mgm.on.ca www.mgm.on.ca PROJECT: EGLIN PARK **REDEVELOPMENT PROJECT** 287-327 Eglin Street East Coburg, Ontario DRAWING: **GRADING PLAN** M. L. STAIRS MAR 29, 2021 BB **BARRY BRYAN** DESIGN BY: DOC CONTROL ASSOCIATES CD % COMPLETE: DRAWN BY: Architects DT Engineers Project Managers INITIAL:

CHECKED BY: CD DATE: JULY 2020 SCALE: 1:300 FILE:

2020-034

DRAWING NO:

CV-3

PROJECT NO: 19284